

> 3,857 SF

NO

30 PSF

SNOW LOAD | SPEED (MPH) | DESIGN

100-110 MPH

CATAGORY

4,018SF

**∑**YES

COMPLIANT

23 Shawnee Road

ARCH 101

WESTCHESTER • NEW YORK

RCHITECT'S SEAL

3 shawnee rd/216002

03/15/16

04/25/16

UNDERLAYMENT | HAZARDS

**FREEZING** 

**INDEX** 

DESIGN

TEMP.

DECAY

MODERATE | SLIGHT TO | 7° F

TO HEAVY | MODERATE


WEATHERING | FROST LINE | TERMITE

DEPTH

SEVERE

Scarsdale N.Y.

23 Shawnee Road Scarsdale, NY Lot: 214 Block: 02 Section: 04

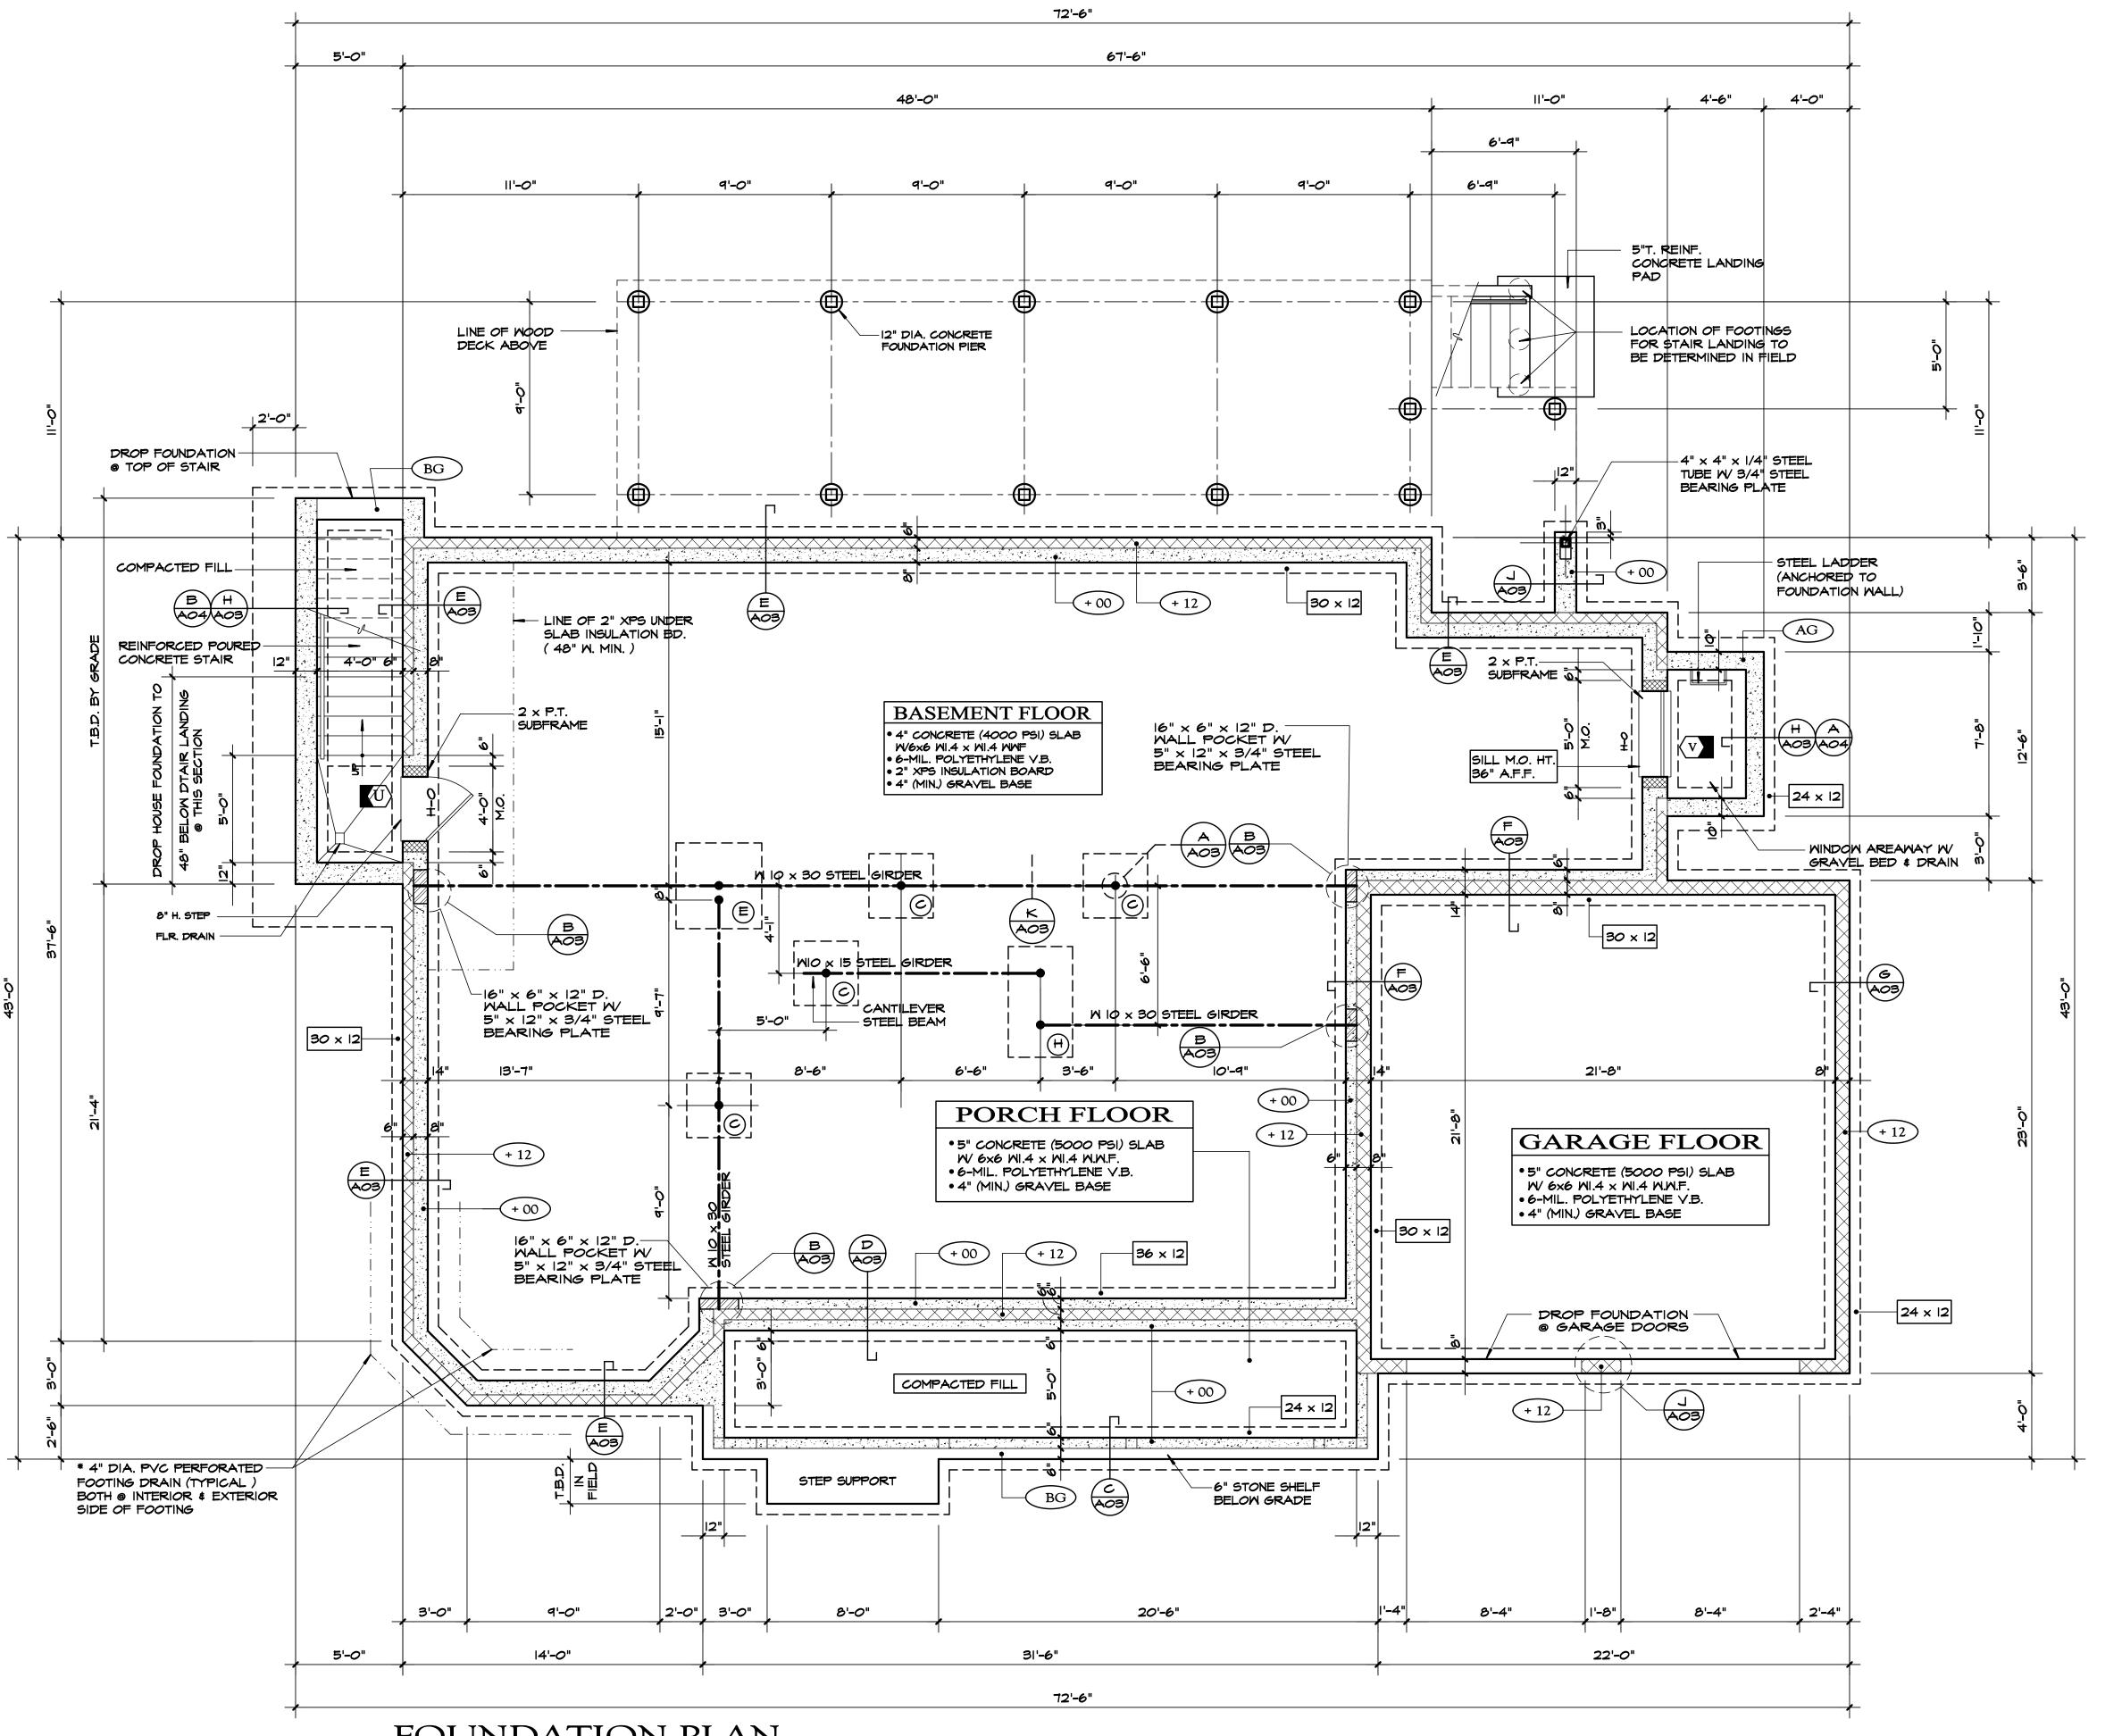

## FOUNDATION PLAN

SCALE: 1/4"= 1'-0"

• REFER TO BASEMENT FLOOR PLAN FOR LOCATION OF PLUMBING FIXTURES AND FLOOR DRAINS. DO NOT DRAIN WINDOW & STAIR WELLS INTO FOOTING DRAINS, PIPE SEPARATELY TO OUTLET • EXTERIOR FLOOR DRAINS (E.G. STAIRWELL) SHALL NOT CONNECT TO FOOTING DRAINS UNDER ANY CIRCUMSTANCE BUT DRAIN TO A SEPARATE OUTLET WHETHER TO A DRYWELL OR DAYLIGHT IF LOCAL CODE PERMITS. REFER TO ENGINEER'S SITE & DRAINAGE PLAN FOR ADDITIONAL INFORMATION.

### GENERAL NOTES

- GENERAL CONTRACTOR SHALL BE RESPONSIBLE TO CHECK & VERIFY ALL FOUNDATION DIMENSIONS ARE ACCURATE & CLOSE PRIOR TO PLACING CONCRETE. NOTIFY ARCHITECT IMMEDIATELY OF ANY
- ALL FOOTINGS MUST BEAR ON SOLID, UNDISTURBED "VIRGIN" SOIL BELOW FROSTLINE
- DESIGN OF ALL CONCRETE SHALL CONFORM TO THE LATEST EDITION OF ACI SPECIFICATIONS AND PRODUCED IN APPROVED MIXING PLANT IN ACCORDANCE WITH ASTM REQUIREMENTS. CONCRETE STRENGTHS FOR VARIOUS USES SHALL BE AS SPECIFIED IN THE FOLLOWING SCHEDULE (MINIMUM COMPRESSIVE STRENGTH, f'c AT 28 DAYS)

• FOOTINGS, FOUNDATIONS & INTERIOR FLOOR SLABS.... • GARAGE AND EXTERIOR FLOOR SLABS.. .5000 PSI

- STEEL BEAMS SHALL CONFORM TO ASTM SPECIFICATIONS A36 FOR
- STRUCTURAL STEEL (Fy = 36 KSI). STEEL COLUMNS SHALL BE STANDARD STEEL PIPE AND CONFORM TO
- ASTM SPECIFICATIONS A53 GRADE B FOR STRUCTURAL STEEL. (Fy = 35 K CEMENT FILL LALLY COLUMNS AND ADJUSTABLE "JACK" COLUMNS ARE NOT ACCEPTABLE FOR USE IN LIEU OF STEEL PIPE COLUMNS
- CMU SHALL BE LOAD BEARING CONCRETE BLOCK LAID LEVEL & PLUMB IN A FULL BED OF CEMENT MORTAR. ALL JOINTS SHALL BE FILLED AND PROPERLY TOOLED. HORIZONTAL JOINTS SHALL BE REINFORCED WITH DUR-O-WALL WIRE AT 16-IN ON CENTER. CEMENT GROUT SOLID CORES WITH STEEL REBAR SHALL BE CEMENT GROUT SOLID.
- BAR REINFORCING STEEL FOR CONCRETE SHALL BE GRADE 60 DEFORMED BARS EXCEPT FOR TIES, WHICH MAY BE PLAIN, SHALL CONFORM TO ASTM SPECIFICATIONS. REINFORCEMENT STEEL BARS (REBAR) SHALL BE NO. 4 UNLESS NOTED OTHERWISE. REFER TO WALL SECTIONS & DETAILS FOR REBAR PLACEMENT.
- PROVIDE WALL AND/OR FOOTING SLEEVES AS REQUIRED FOR UTILITIE ). PROVIDE 5/8-IN. DIAMETER x 18-IN. GALVANIZED ANCHOR J-BOLT AT 48-IN O.C. (MAX) TO SECURE MUD SILL PLATES TO TOP OF FOUNDATION WAL 1. FILLED AREAS TO BE MECHANICALLY COMPACTED.
- 12. PROVIDE FOOTING DRAINS TO DRYWELLS OR STORM SEWER.
- 3. PROVIDE PRESSURE TREATED (PT) 2x SUB-FRAME AT WINDOW AND DOOF FOUNDATION OPENINGS.
- 14. FLATWORK SCHEDULE WHERE APPLICABLE:

BASEMENT FLOOR SLAB	4-IN. THIC
• INTERIOR FLOOR SLAB	•
CRAWL SPACE FLOOR SLAB	2-IN. THIC
GARAGE FLOOR SLAB	5-IN. THIC
EXTERIOR FLOOR SLAB	5-IN. THI

- 15. ALL SLABS EXCEPT AT CRAWL SPACE SHALL BE REINFORCED WITH 6 x 6 W1.4 x W1.4 W.W.M. PITCH GARAGE AND EXTERIOR SLABS FOR DRAINAGE. PROVIDE A COMPACTED GRAVEL BASE (4-IN. MIN.) BENEATH ALL CONCRETE FLOOR SLABS
- 5. PROVIDE 6-MIL. POLYETHYLENE VAPOR BARRIER UNDER ALL INTERIOR FLOOR SLABS INCLUDING GARAGE.
- 7. ALL STEEL GIRDER, COLUMN PLATES, ETC....SHALL BE SHOP PRIMED WIT (1) COAT OF RUST PROHIBITOR & A SECOND COAT APPLIED IN THE FIEL
- 8. PROVIDE COPPER TERMITE SHIELD AT TOP OF FOUNDATION WALLS ENCLOSING THE CRAWL SPACE IF SHOWN AS PER WALL SECTION. MAINTAIN SEPARATION FROM P.T. MUDSILL WITH E.P.S. SILL SEALER.

### LEGEND

EXISTING FOUNDATION WALL (VERIFY IN FIELI \_\_\_\_\_ POURED CONCRETE FOUNDATION WALL W/ REINFORCED POURED CONCRETE FOOTING \_\_\_\_\_ \_\_\_\_\_

CMU FOUNDATION WALL W/ REINFORCED POURED CONCRETE FOOTING \_\_\_\_\_

FOUNDATION WALL SHELF FOR MASONRY VENEER BEARING (SET SHELF 6" MIN. BELOW FINISHED GRADE) ----\_\_\_<u>STEM</u>\_\_

 $\times$   $\times$   $\times$   $\times$   $\times$ 

FOUNDATION STEM WALL (SEE DETAIL) \_\_\_\_\_ BEAM WALL POCKET 12" x 5" x 3/4" STEEL BEARING PLATE

POURED CONCRETE CYLINDRICAL PIER EXISTING STEEL COLUMN (VERIFY IN FIELD)

\* 4" O.D. STANDARD STEEL PIPE COLUMN BASE PLATE: 8" x 8" x 3/4" STEEL PLATE TOP PLATE: 10" x 5 1/2" x 3/4" STEEL PLATE \* UNLESS NOTED OTHERWISE ON PLANS.

 $|24 \times 12|$ FOOTING SIZE (W x D INCHES) (+00) TOP OF WALL ELEVATION (INCHES)

TOP OF WALL BELOW FINISH GRADE BG (6" MIN.) TOP OF WALL ABOVE FINISH GRADE ( AG )

### FOOTING SCHEDULE

(6" MIN.)

FOOTING REINFORCEMENT SHALL BE NO. 4 REBAR @ 9" O.C. EACH WAY (MAT REINFORCEMENT)

SIZE

$\otimes$	EXISTING FOOTING (VERIFY IN FIELD)
<b>(A)</b>	24" x 24" x 12" D. CONCRETE FOOTING
B	30" x 30" x 12" D. CONCRETE FOOTING
(0)	36" x 36" x 15" D. CONCRETE FOOTING
(d)	42" x 42" x 15" D. CONCRETE FOOTING
Œ	48" x 48" x 15" D. CONCRETE FOOTING

ARCH 101

WESTCHESTER • NEW YORK

03/15/16

04/25/16

24" x (L) x 12" D. CONCRETE FOOTING \* DATE: 30" x (L) x 12" D. CONCRETE FOOTING \* REVISIONS: 36"  $\times$  (L)  $\times$  15" D. CONCRETE FOOTING \* 42" x (L) x 15" D. CONCRETE FOOTING \*

ENGAGED FOOTING W/ FOUNDATION OR CHIMNEY

DISTANCE BETWEEN COLUMNS & THE FOOTING WIDTH DO NOT SCALE PRINTS

NOTE: THE LENGTH (L) OF FOOTING SHALL BE THE SUM OF THE

48" x (L) x 15" D. CONCRETE FOOTING  $\,^*$ 

RCHITECT'S SEAL DWG No. **FOUNDATION** 


3 shawnee rd/216002


23 Shawnee Road, LLC


23 Shawnee Road

Proposed Residence

Scarsdale N.Y.

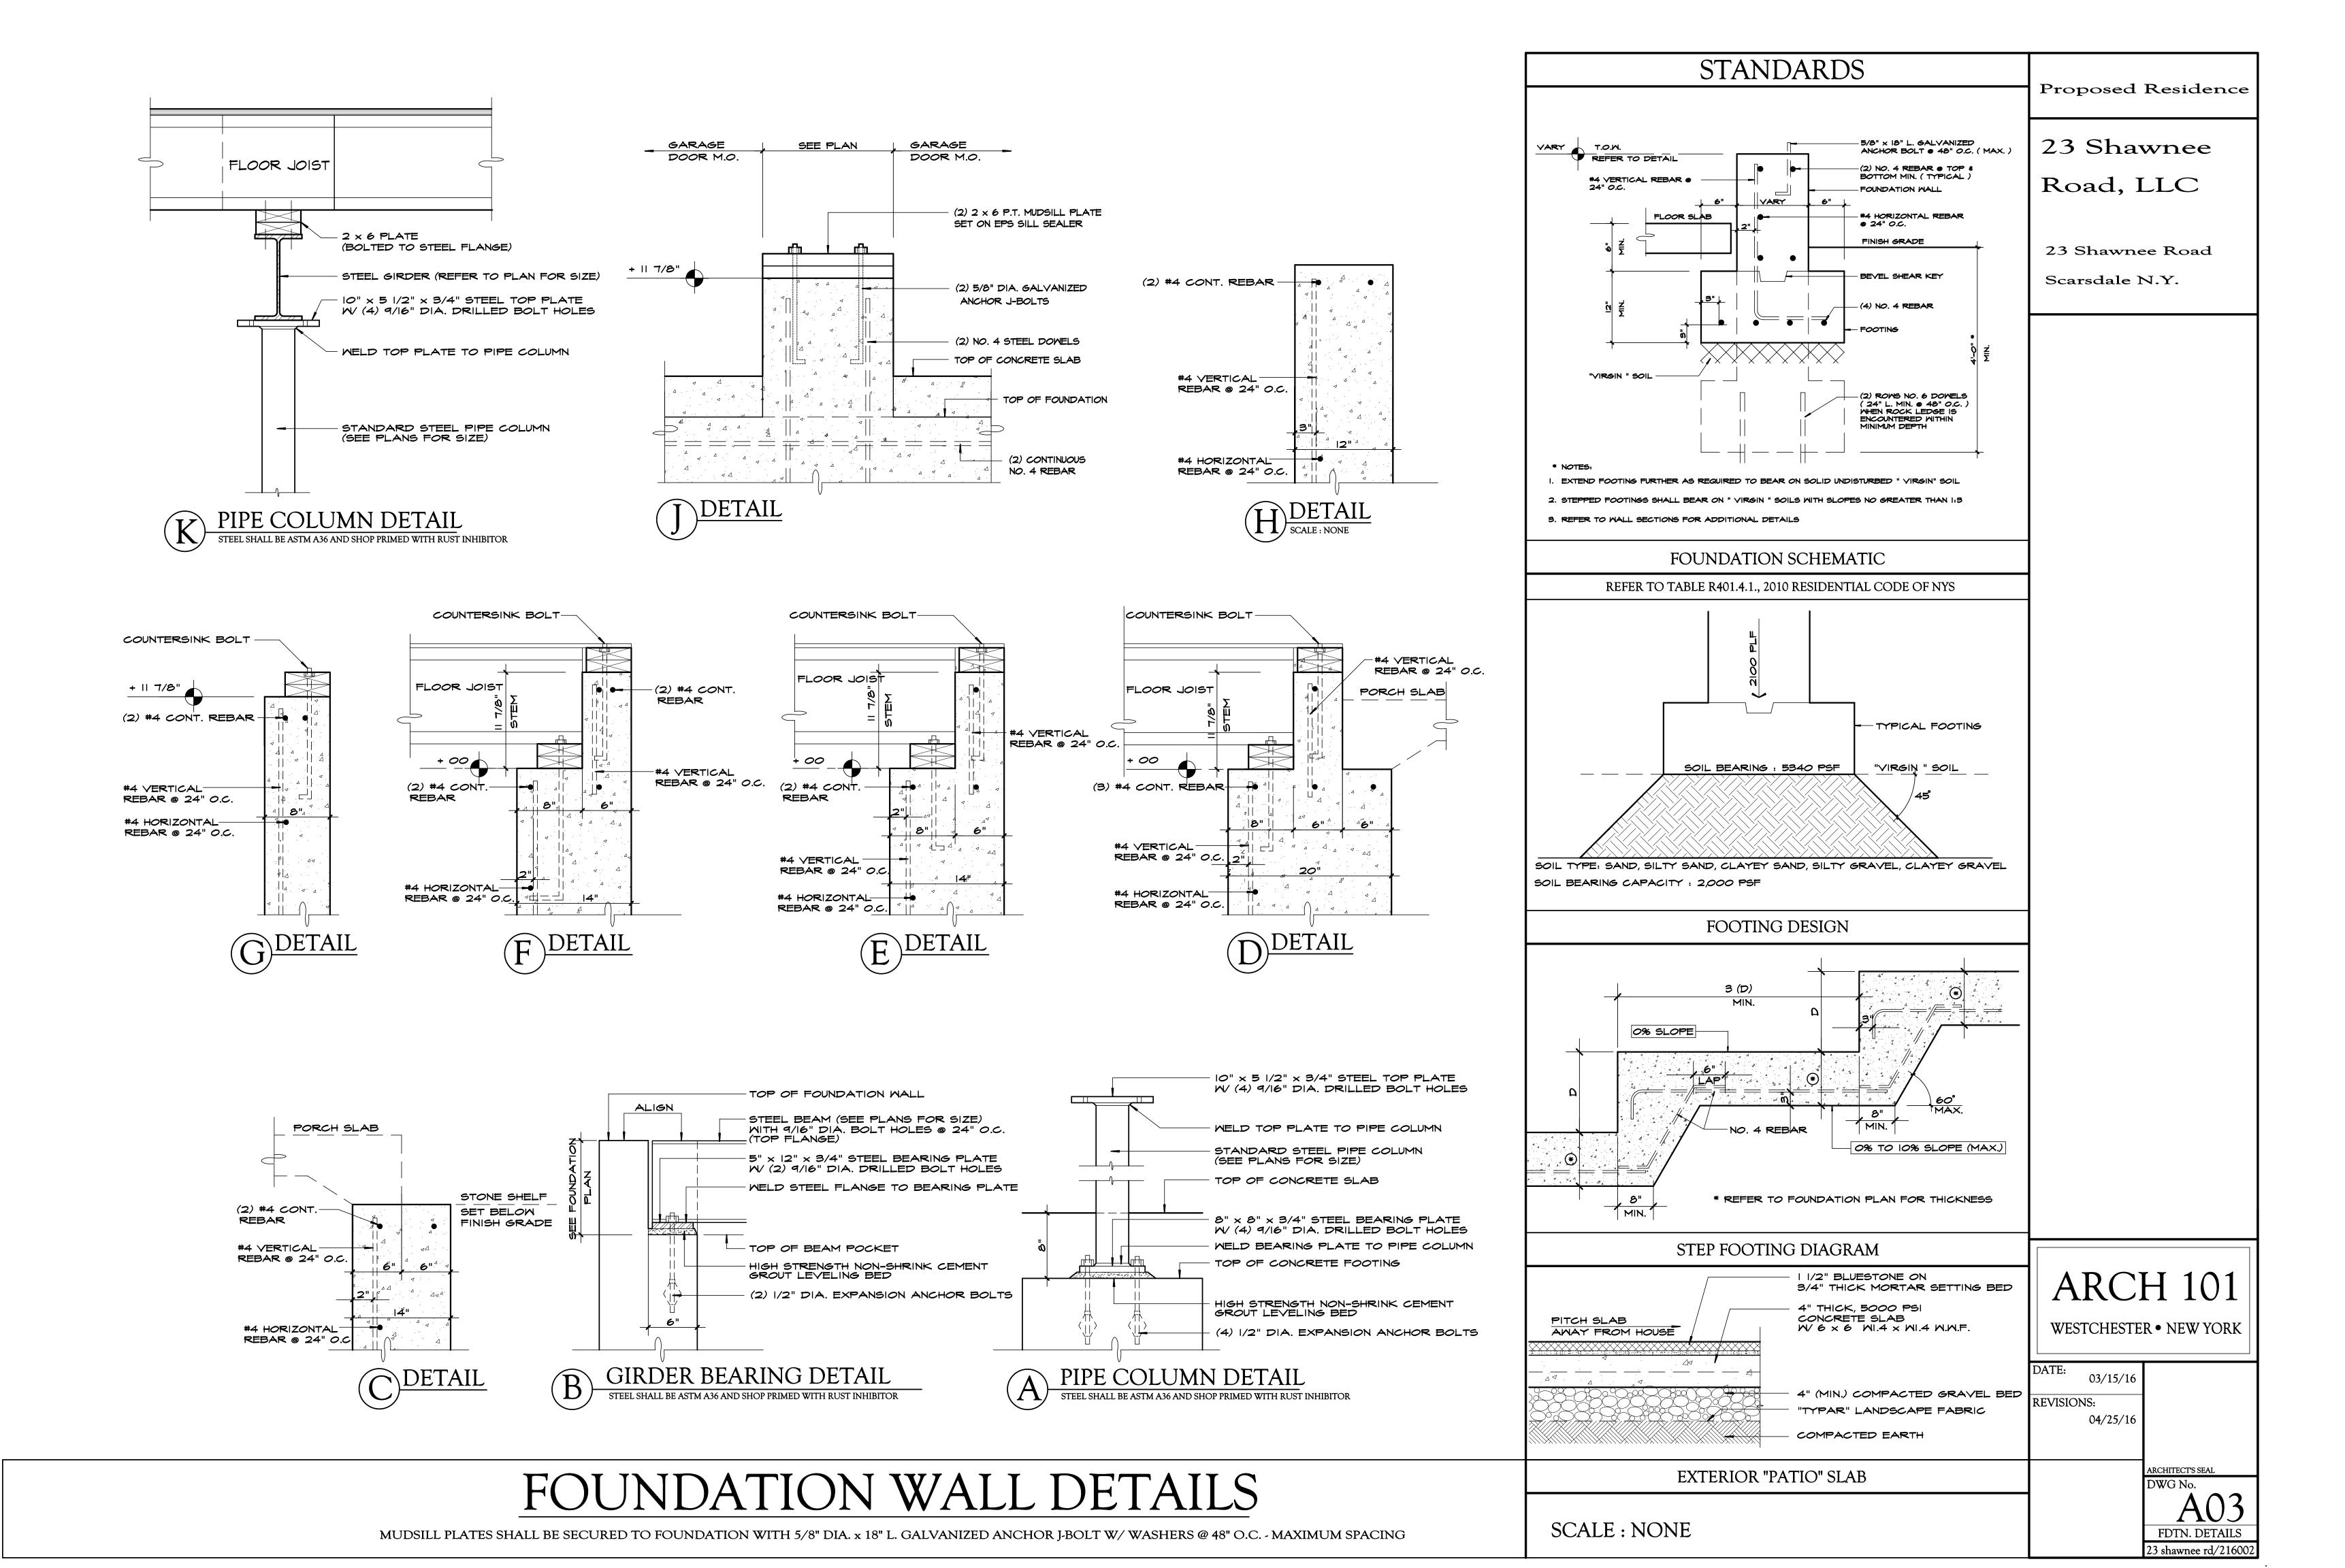

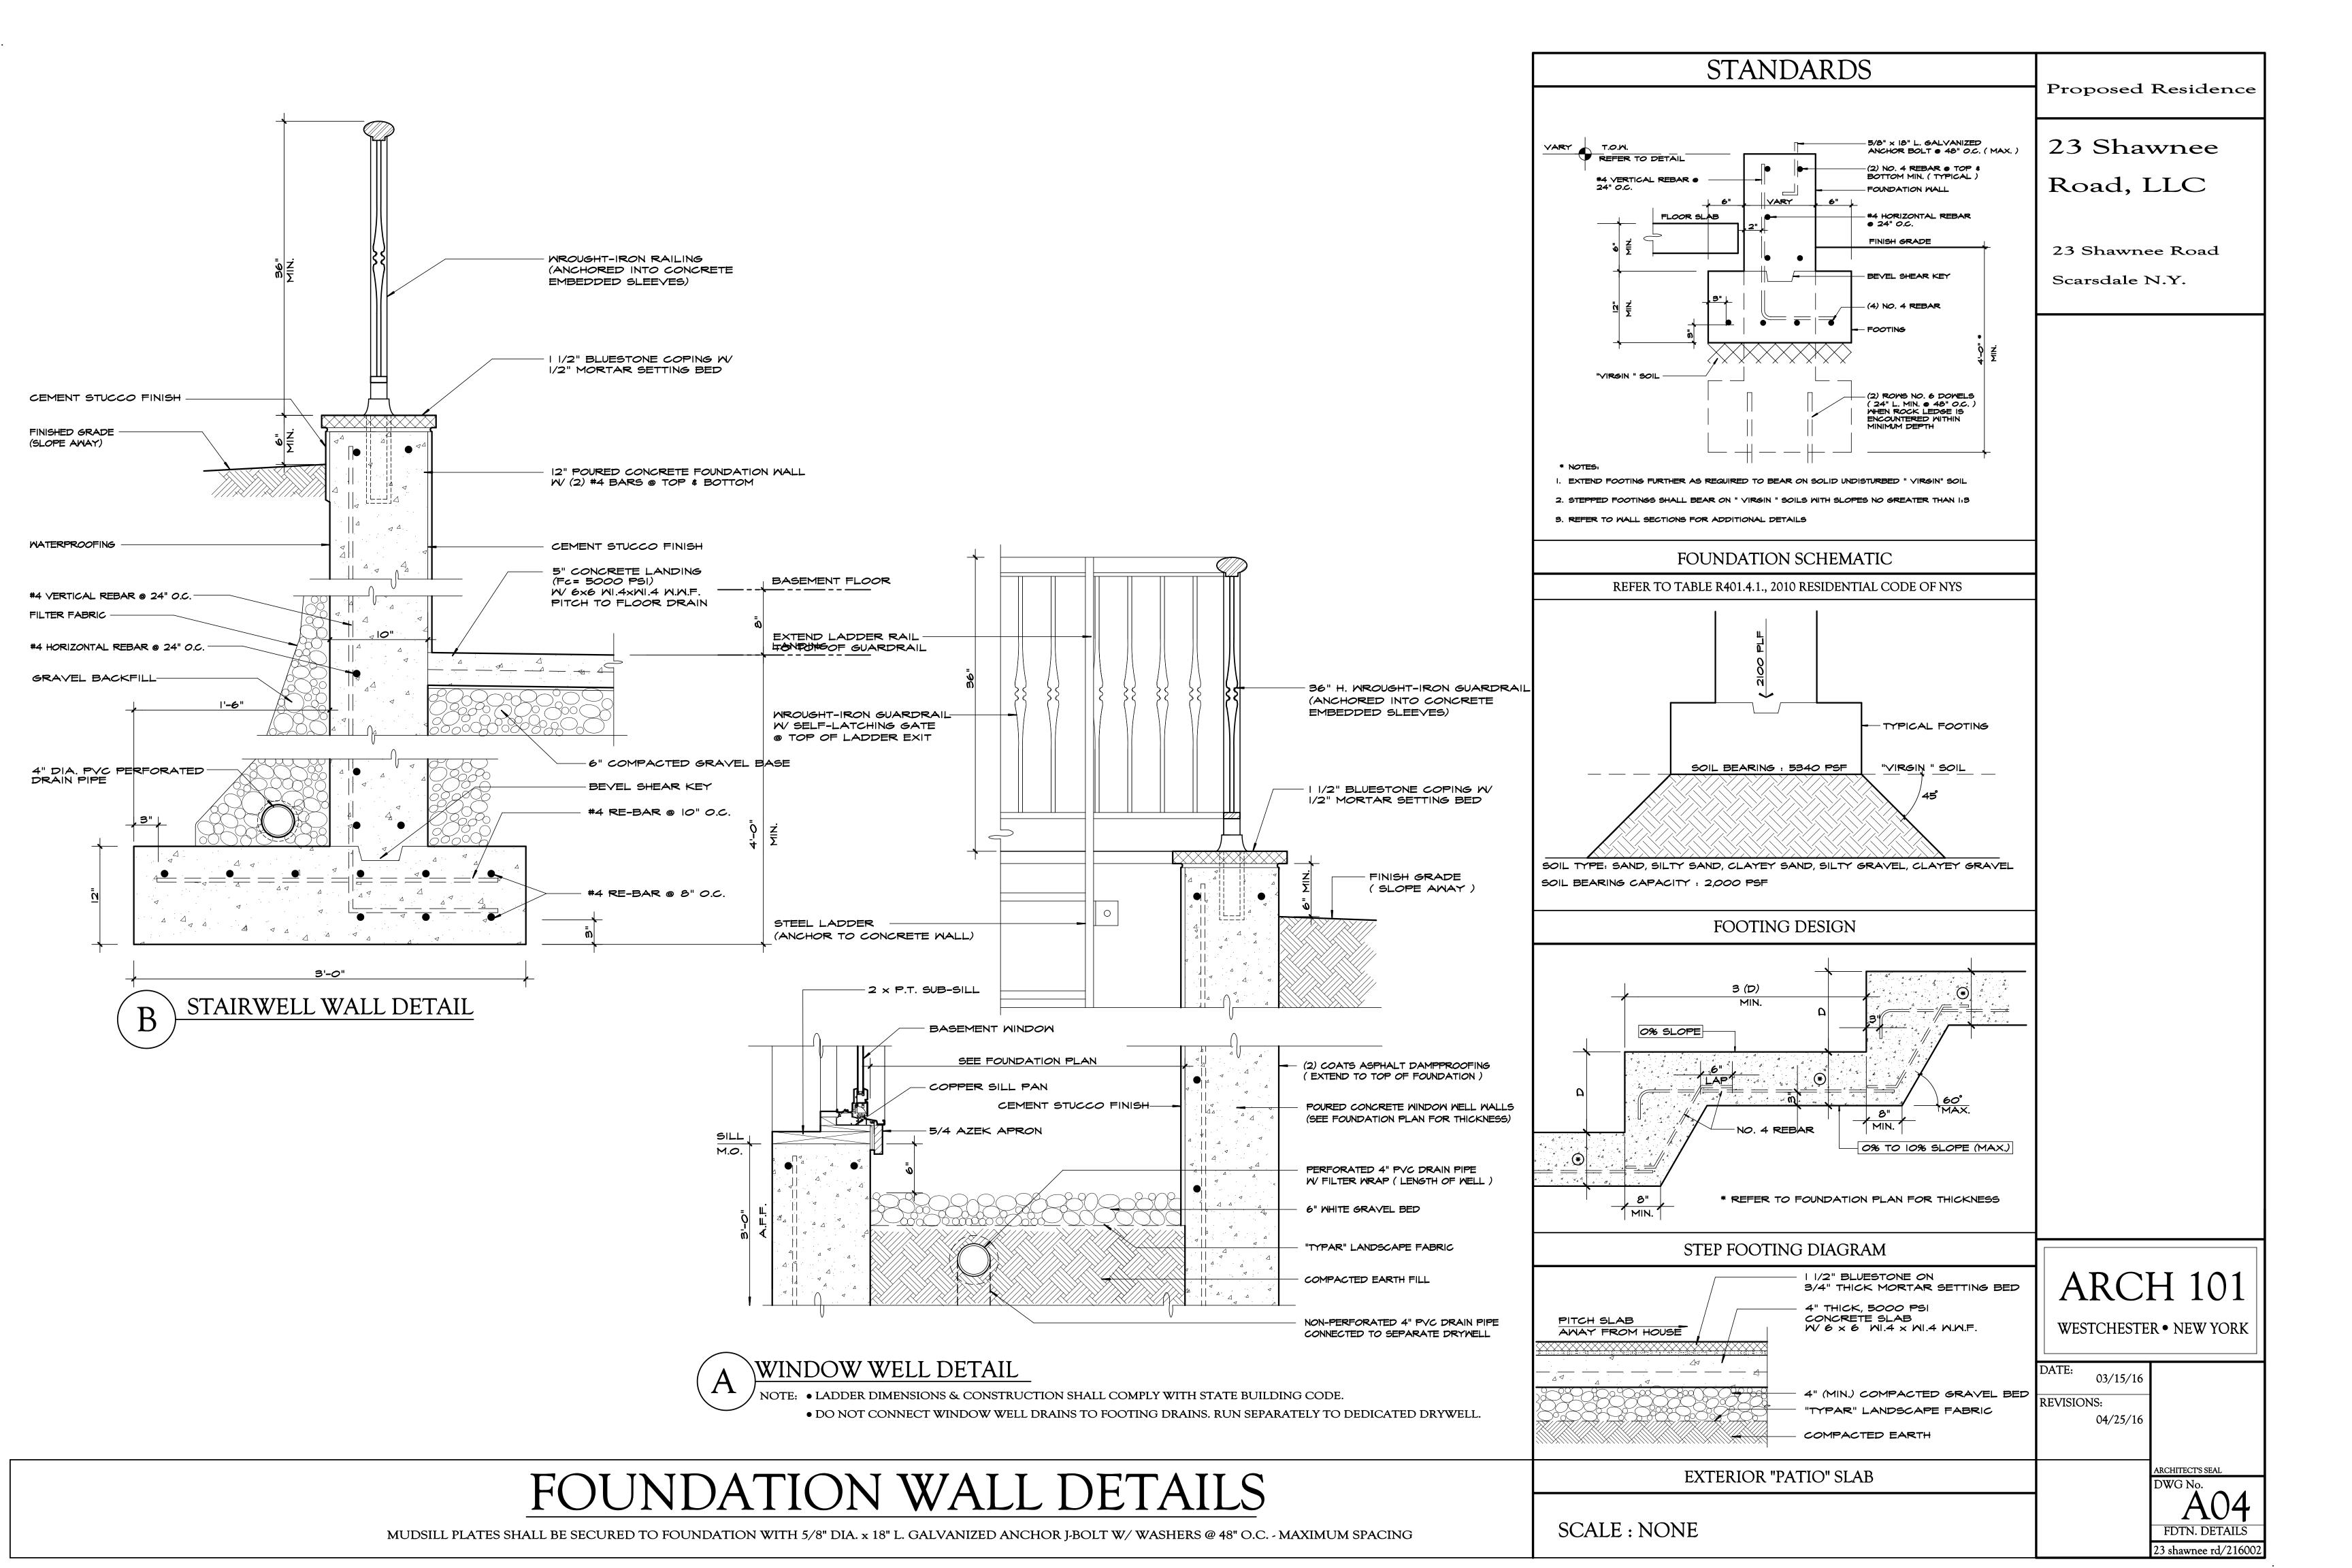

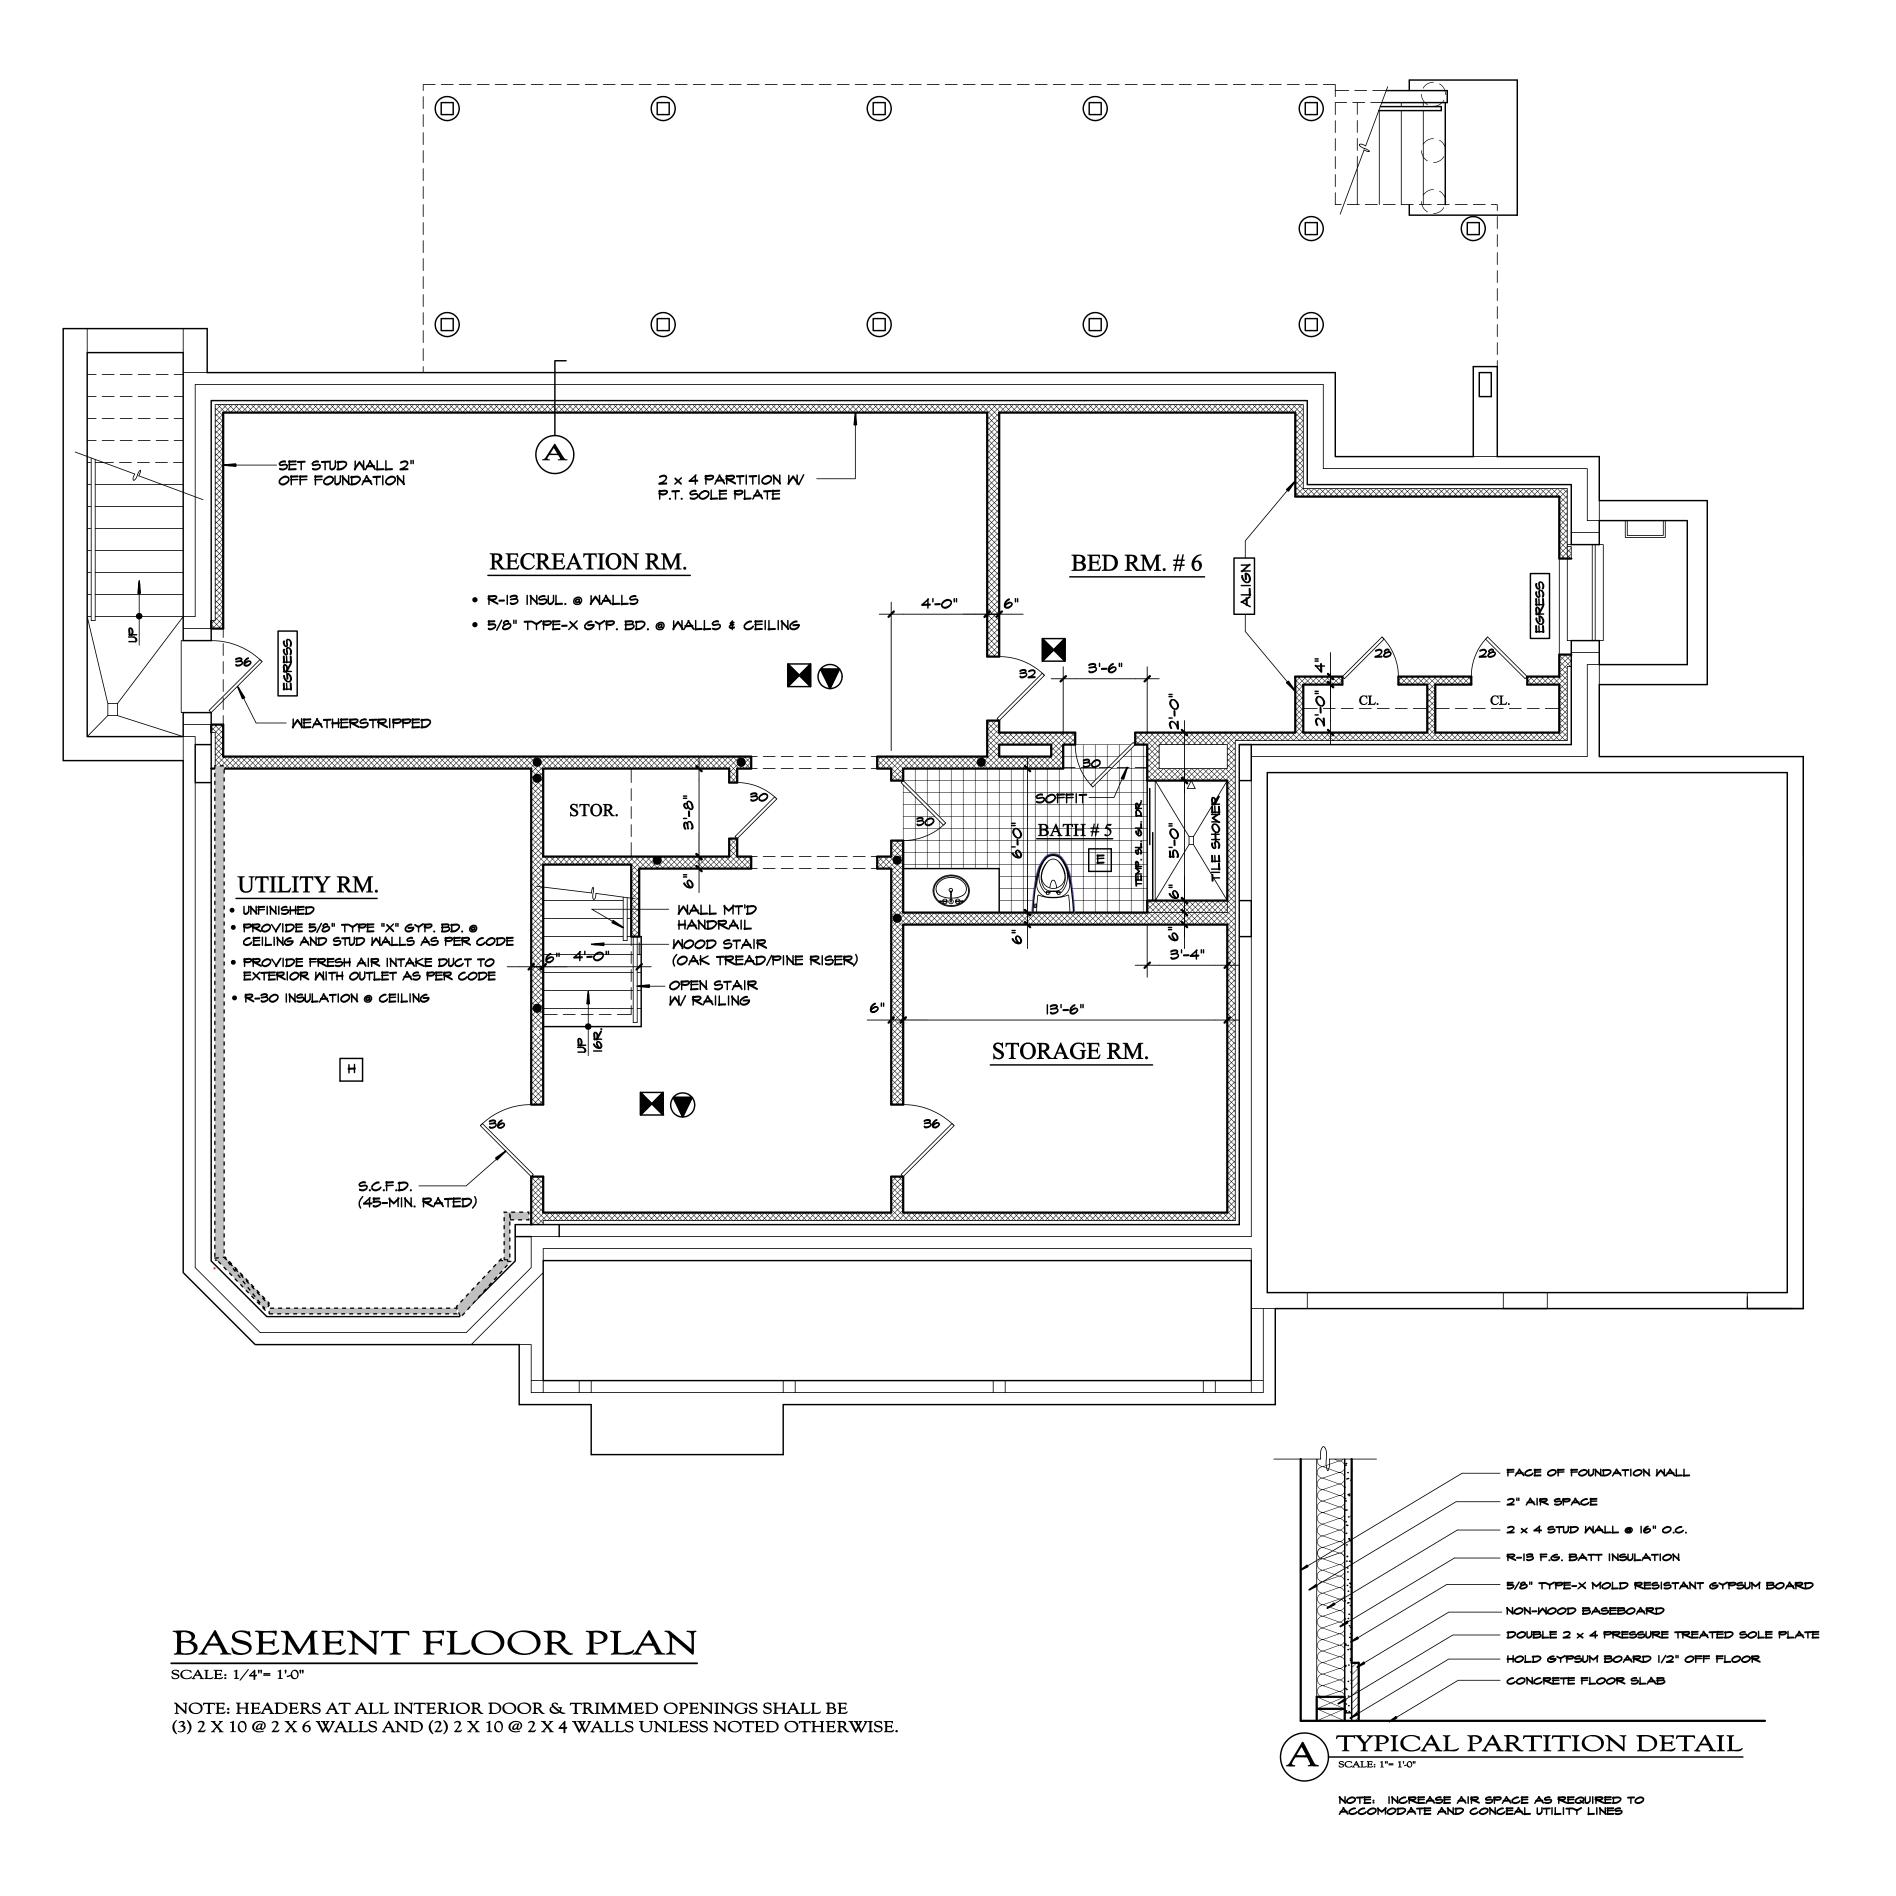

### LIGHT & VENTILATION CALCULATIONS | Proposed Residence SQ. FT. LIGHT (8% MIN.) ROOM VENT. (4% MIN. HABITABLE 23 Shawnee ROOM REQUIRED PROVIDED ₹ | REQUIRED | PROVIDED (<u>≥</u>7'-6" C.H.) Road, LLC 456 24.00 24.00 36.48 RECREATION RM. 273 21.84 14.62 10.92 8.18 BEDROOM #6 3.32 23 Shawnee Road BATH #5 Scarsdale N.Y. 22.00 85.40 36.90 LIVING ROOM 221 36.76 19.92 17.68 DINING ROOM 326 FAMILY ROOM 26.08 13.04 44.13 395 15.80 27.73 31.60 74.41 KITCHEN POWDER ROOM 11.20 23.44 M. BEDROOM 139 5.56 17.58 M. BATH 11.12 31.44 177 20.96 7.08 11.72 BEDROOM #2 14.16 49 3.92 1.98 5.86 BATH #2 10.48 186 14.88 20.96 17.58 BEDROOM #3 3.60 10.48 5.86 BATH #3 202 BEDROOM #4 16.16 20.96 17.58 4.80 3.68 6.31 BATH #4 7.88 17.54 24.79 BEDROOM #5 15.76 4.32 2.16 LAUNDRY RM. UNFINISHED ARTIFICIAL LIGHT ARCH 101 • NUMBER(I) x 100 WATTS, MINIMUM POWER OF ILLUMINATION REQUIRED TO COMPLY WITH CHAPTER 3, SECTION R303.1 OF THE NYS RESIDENTIAL CODE. WESTCHESTER • NEW YORK • A MINIMUM OF 50 PERCENT OF THE LAMPS IN PERMANENTLY INSTALLED LIGHTING FIXTURES ARE HIGH EFFICACY LAMPS PER 404.1 OF 2010 ENERGY CONSERVATION CONSTRUCTION CODE OF N.Y.S. DATE: 03/15/16

**REVISIONS:** 

04/25/16

ARCHITECT'S SEAL

23 shawnee rd/216002

ARTIFICIAL VENTILATION

(COMPLY WITH SECTION R301.3)


(COMPLY WITH SECTION R303.3)

• RECREATION AND LAUNDRY ROOM WILL BE MECHANICALLY

DO NOT SCALE PRINTS

VENTILATED WITH AN AIR EXCHANGE OF .35/HR MIN.

• BATHROOM EXHAUST FANS SHALL BE 50 CFM, MIN.

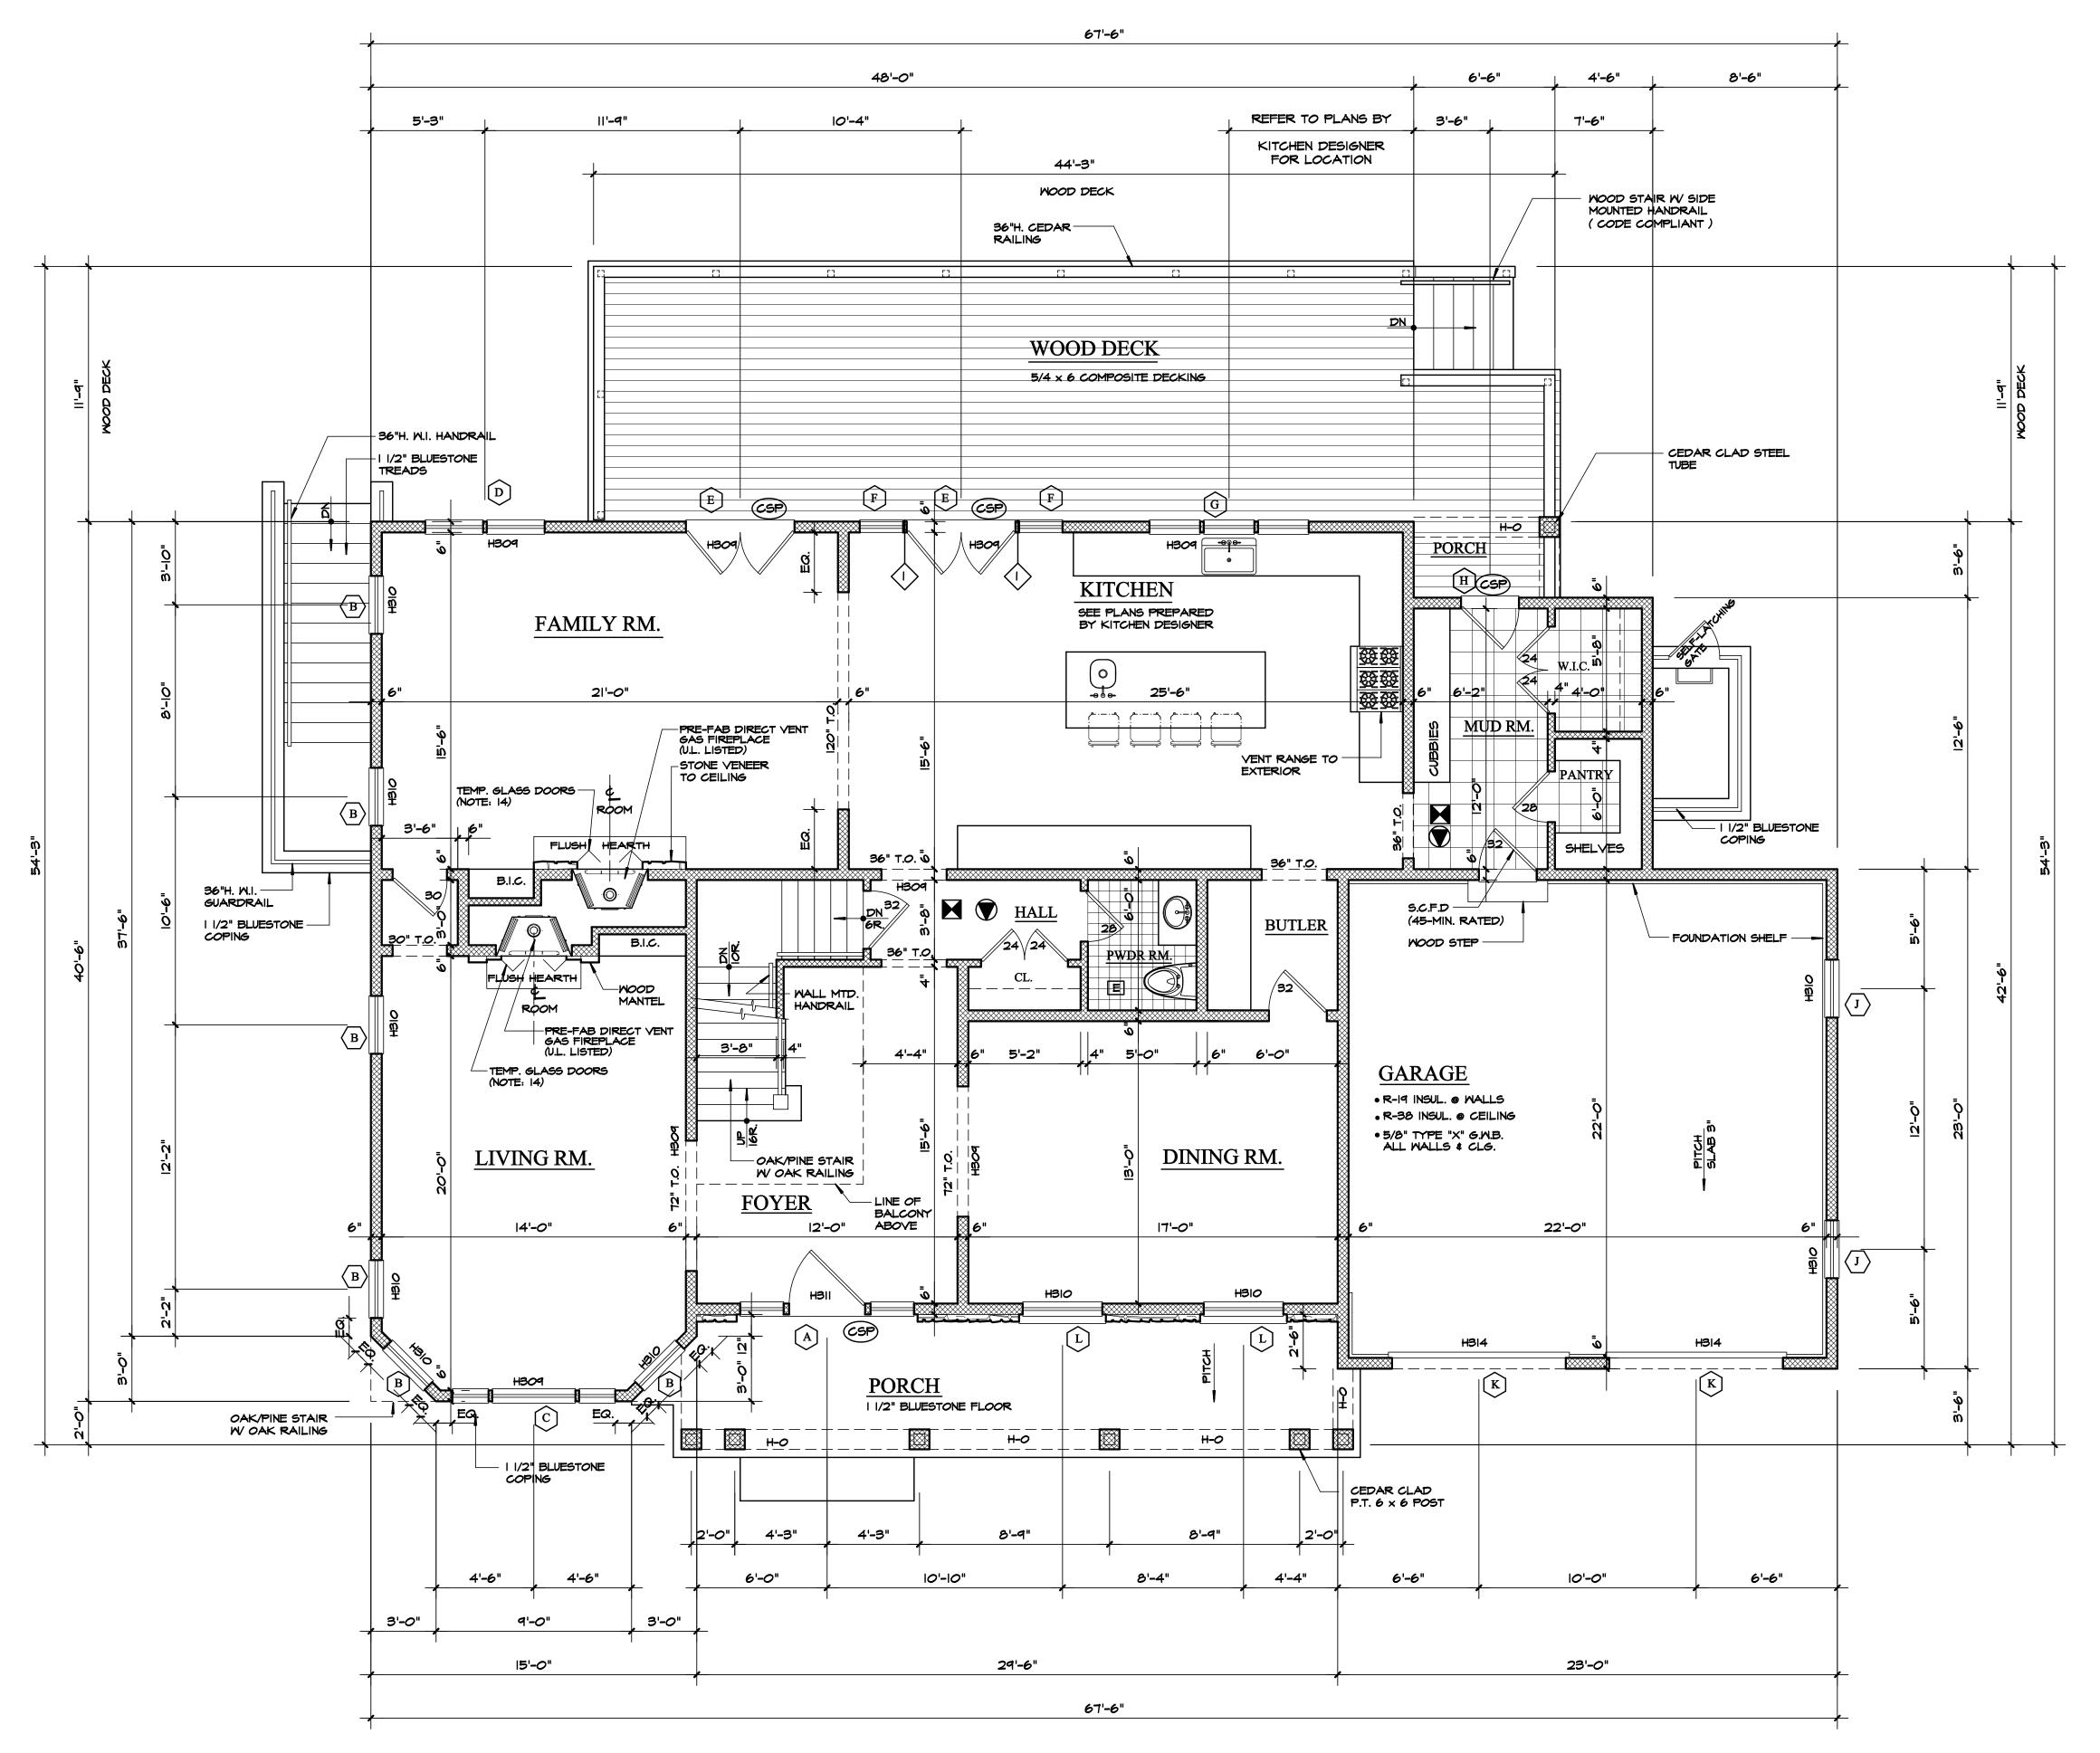

### FIRST FLOOR PLAN

SCALE: 1/4"= 1'-0"

NOTE: HEADERS AT ALL INTERIOR DOOR & TRIMMED OPENINGS SHALL BE (3) 2 X 10 @ 2 X 6 WALLS AND (2) 2 X 10 @ 2 X 4 WALLS UNLESS NOTED OTHERWISE

## GENERAL NOTES

- PLUMBING FIXTURE LAYOUT. G.C. SHALL PROVIDE CABINET SOFFIT AND APPLIANCE AS REQUIRED.
- SEE WINDOW AND DOOR SCHEDULE FOR TYPES. PROVIDE 16 OZ. COPPER SILL PAN FLASHING AT ALL EXTERIOR DOOR ROUGH OPENINGS AND AT WINDOWS
- PROVIDE 15# ASPHALT WRAP AT ALL WINDOW AND DOOR OPENINGS AS PER DETAIL ON WINDOW & DOOR SCHEDULE
- PROVIDE FIREBLOCKING AT ALL SOFFITS AND TUBS. . FLUE CHASES SHALL BE FIREBLOCKED AT EACH FLOOR LEVEL INCLUDING ATTIC.

IMMEDIATELY ABOVE A ROOF (REVIEW WITH ARCHITECT).

- . INSULATE ALL INTERIOR WALLS THROUGHOUT AS WELL AS ENTIRE FLOOR UNDER SECOND FLOOR ROOMS W/ UNFACED F.G. BATTS FOR SOUND DEADENING.
- WALLS AND CEILING. PROVIDE FROST-FREE HOSE BIBS AS NEEDED. REVIEW

PROVIDE 5/8" TYPE-X GYPSUM BOARD THROUGHOUT

- LOCATIONS WITH G.C.
- 10. FLOORING IN NON-TILED ROOMS UNLESS NOTED OTHERWISE SHALL BE CLEAR GRADE RED OAK,

G.C. SHALL SELECT BOARD WIDTH DIMENSION.

- 11. TILE WORK SHALL BE AS PER TCA SPECS (LATEST EDITION). 12. G.C. SHALL SELECT ALL CABINETRY.
- 13. G.C. SHALL SELECT DOOR HARDWARE.
- 14. PROVIDE TIGHT-FITTING NON-COMBUSTIOUS GLASS DOORS AT EACH FIREPLACE IN CONFORMANCE WITH E102.5 OF THE NYS ENERGY CODE
- 15. PRIME AND PAINT ALL DRYWALL (3 COATS; 1 PRIME & 2 FINISH). STAIN AND POLYURETHANE ALL OAK WOOD (FURNITURE QUALITY FINISH). REVIEW TYPES AND COLORS WITH OWNER PRIOR TO START OF WORK. SUBMIT SAMPLES TO G.C. FOR REVIEW AND APPROVAL.

REVIEW HEATING AND AIR CONDITIONING REQUIREMENTS WITH OWNER AND SUBMIT PROPOSED SYSTEM AND SPECIFICATIONS FOR OWNER'S APPROVAL.

SHALL COMPLY WITH 2010 N.Y.S. RESIDENTIAL CODE, **SECTION R311 & R312** 

SECTION ROTT & ROT	2			
STAIR LOCATION	MAIN	BACK	BASEMENT	
WIDTH	48"	40"	44"	
TREAD	9"	9"	9"	
RISER	7.6" +/-	7.6" +/-	7.6" +/-	
HEADROOM	80" <	80" <	80" <	
HANDRAIL GRIP	TYPE 1			
BALUSTER SPACING	LESS THAN 4" O.C.			
HANDRAIL HEIGHT	36"			
GUARDRAIL HEIGHT	42"			

# LEGEND

EXISTING WALL (VERIFY IN FIELD)

NEW WOOD STUD WALL 2 x @ 16" O.C.

POURED CONCRETE WALL

CMU WALL (CEMENT GROUT SOLID)

STONE VENEER BRICK VENEER

32 DOOR SIZE (NOTED IN INCHES)

₩ WINDOW TYPE \*

**HEADER SIZE \*** 

COPPER SILL PAN

NUMBER OF STUDS (MULL OR JACK)

LINTEL SIZE \*

EXHAUST FAN (50 CFM, MIN.) VENT TO EXTERIOR W/ METAL DUCT

FROST FREE HOSE BIB

**HEAT SENSOR** HARD WIRED W/ BATTERY BACKUP (U.L. LISTED) INTERCONNECTED, NFPA 72 COMPLIANCE HARD WIRED W/ BATTERY BACKUP (U.L. LISTED)

INTERCONNECTED, NFPA 72 COMPLIANCE CARBON MONOXIDE ALARM HARD WIRED W/ BATTERY BACKUP (U. L. LISTED) INTERCONNECTED, NFPA 72 COMPLIANCE

\* REFER TO WINDOW & DOOR SCHEDULE SHEET FOR SCHEDULES AND SPECIFICATIONS

DO NOT SCALE PRINTS

ARCH 101

WESTCHESTER • NEW YORK

Proposed Residence

23 Shawnee

Road, LLC


23 Shawnee Road

Scarsdale N.Y.

DATE: 03/15/16 REVISIONS:

04/25/16 ARCHITECT'S SEAL

> FIRST FLOOR 23 shawnee rd/216002

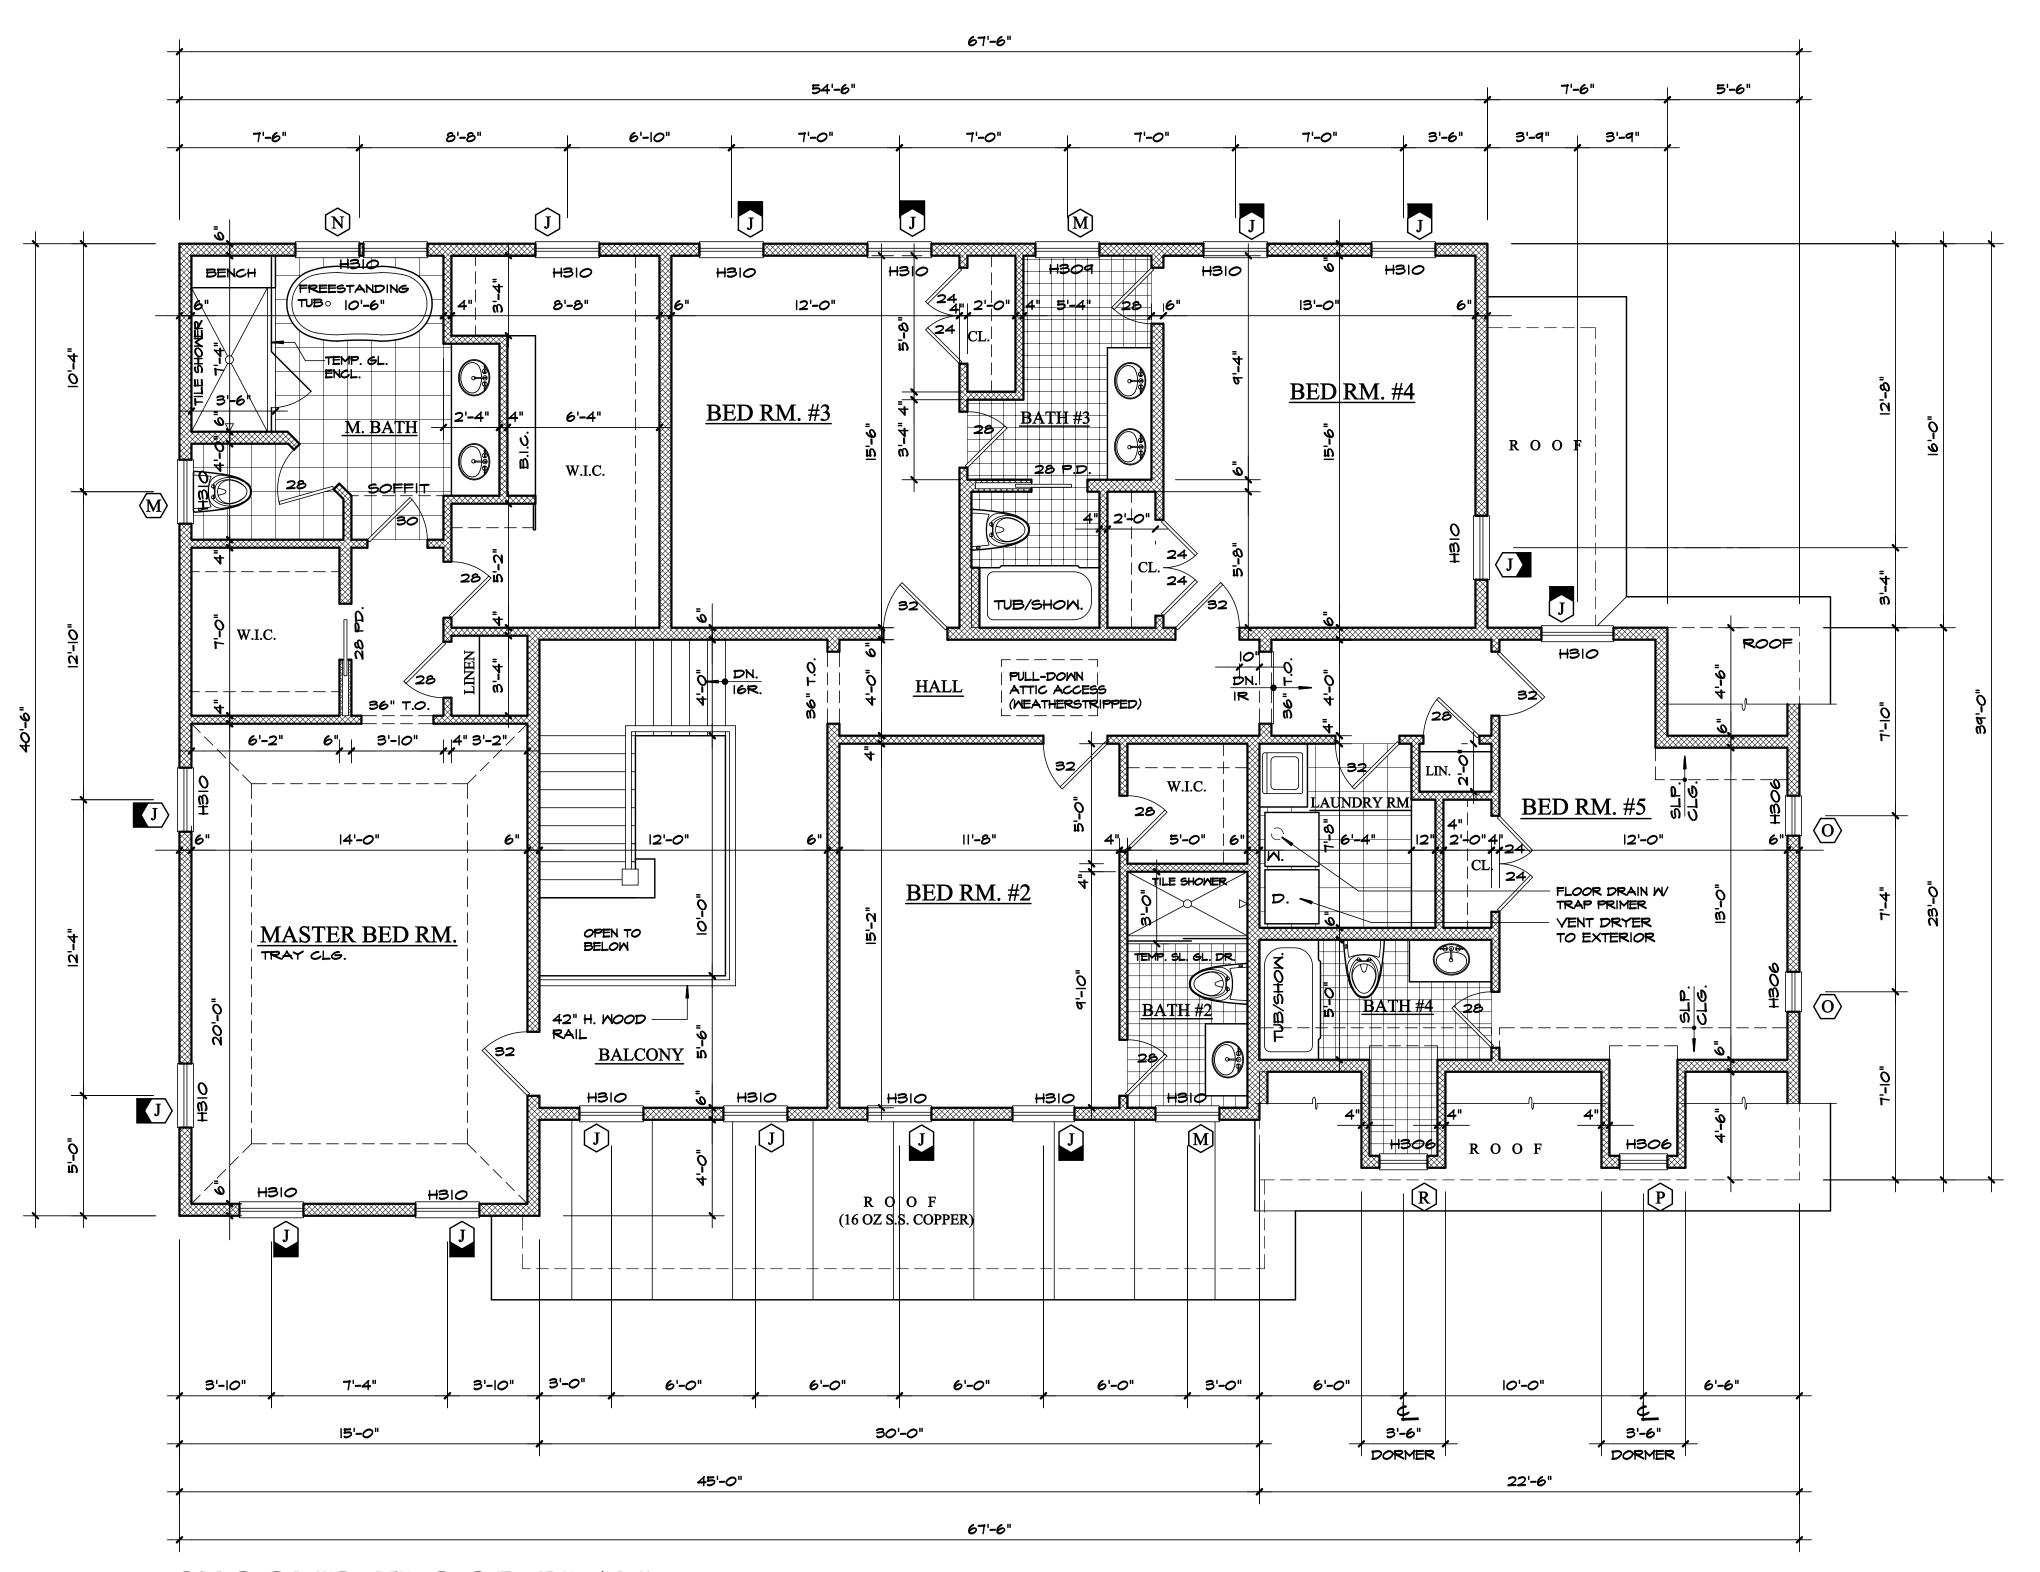

### SECOND FLOOR PLAN

SCALE: 1/4"= 1'-0"

NOTE: HEADERS AT ALL INTERIOR DOOR & TRIMMED OPENINGS SHALL BE (3)  $2 \times 10$  @  $2 \times 6$  WALLS AND (2)  $2 \times 10$  @  $2 \times 4$  WALLS UNLESS NOTED OTHERWISE

- PLUMBING FIXTURE LAYOUT. G.C. SHALL PROVIDE CABINET SOFFIT AND APPLIANCE AS REQUIRED.
- SEE WINDOW AND DOOR SCHEDULE FOR TYPES. PROVIDE 16 OZ. COPPER SILL PAN FLASHING AT ALL EXTERIOR DOOR ROUGH OPENINGS AND AT WINDOWS
- IMMEDIATELY ABOVE A ROOF (REVIEW WITH ARCHITECT). 4. PROVIDE 15# ASPHALT WRAP AT ALL WINDOW AND DOOR
- OPENINGS AS PER DETAIL ON WINDOW & DOOR SCHEDULE . PROVIDE FIREBLOCKING AT ALL SOFFITS AND TUBS.
- . FLUE CHASES SHALL BE FIREBLOCKED AT EACH FLOOR LEVEL INCLUDING ATTIC. . INSULATE ALL INTERIOR WALLS THROUGHOUT AS WELL
- AS ENTIRE FLOOR UNDER SECOND FLOOR ROOMS W/ UNFACED F.G. BATTS FOR SOUND DEADENING. PROVIDE 5/8" TYPE-X GYPSUM BOARD THROUGHOUT
- WALLS AND CEILING. PROVIDE FROST-FREE HOSE BIBS AS NEEDED. REVIEW
- LOCATIONS WITH G.C. 10. FLOORING IN NON-TILED ROOMS UNLESS NOTED
- G.C. SHALL SELECT BOARD WIDTH DIMENSION. 11. TILE WORK SHALL BE AS PER TCA SPECS (LATEST EDITION).

OTHERWISE SHALL BE CLEAR GRADE RED OAK,

- 12. G.C. SHALL SELECT ALL CABINETRY.
- 13. G.C. SHALL SELECT DOOR HARDWARE.
- 14. PROVIDE TIGHT-FITTING NON-COMBUSTIOUS GLASS DOORS AT EACH FIREPLACE IN CONFORMANCE WITH E102.5 OF THE NYS ENERGY CODE
- 15. PRIME AND PAINT ALL DRYWALL (3 COATS; 1 PRIME & 2 FINISH). STAIN AND POLYURETHANE ALL OAK WOOD (FURNITURE QUALITY FINISH). REVIEW TYPES AND COLORS WITH OWNER PRIOR TO START OF WORK. SUBMIT SAMPLES TO G.C. FOR REVIEW AND APPROVAL.

REVIEW HEATING AND AIR CONDITIONING REQUIREMENTS WITH OWNER AND SUBMIT PROPOSED SYSTEM AND SPECIFICATIONS FOR OWNER'S APPROVAL.

SHALL COMPLY WITH 2010 N.Y.S. RESIDENTIAL CODE, **SECTION R311 & R312** 

eberien ieri <b>a</b> ier	2		
STAIR LOCATION	MAIN	BACK	BASEMENT
WIDTH	48"	40"	44"
TREAD	9"	9"	9"
RISER	7.6" +/-	7.6" +/-	7.6" +/-
HEADROOM	80" <	80" <	80" <
HANDRAIL GRIP	TYPE 1		
BALUSTER SPACING	LESS THAI	N 4" O.C.	
HANDRAIL HEIGHT	36"		
GUARDRAIL HEIGHT	42"		

# LEGEND

EXISTING WALL (VERIFY IN FIELD)

NEW WOOD STUD WALL 2 x @ 16" O.C.

POURED CONCRETE WALL

CMU WALL (CEMENT GROUT SOLID)

STONE VENEER

32 DOOR SIZE (NOTED IN INCHES)

BRICK VENEER

₩INDOW TYPE \*

EGRESS WINDOW \*

₩ HEADER SIZE \*

COPPER SILL PAN

NUMBER OF STUDS (MULL OR JACK)

LINTEL SIZE \*

EXHAUST FAN (50 CFM, MIN.) VENT TO EXTERIOR W/ METAL DUCT

FROST FREE HOSE BIB

**HEAT SENSOR** HARD WIRED W/ BATTERY BACKUP (U.L. LISTED) INTERCONNECTED, NFPA 72 COMPLIANCE

HARD WIRED W/ BATTERY BACKUP (U.L. LISTED) INTERCONNECTED, NFPA 72 COMPLIANCE CARBON MONOXIDE ALARM HARD WIRED W/ BATTERY BACKUP (U. L. LISTED)

> \* REFER TO WINDOW & DOOR SCHEDULE SHEET FOR SCHEDULES AND SPECIFICATIONS

ARCH 101

WESTCHESTER • NEW YORK

Proposed Residence

23 Shawnee

Road, LLC

23 Shawnee Road


Scarsdale N.Y.

DATE: 03/15/16 **REVISIONS:** 04/25/16

> ARCHITECT'S SEAL SECOND FLOOR 23 shawnee rd/216002

DO NOT SCALE PRINTS

INTERCONNECTED, NFPA 72 COMPLIANCE

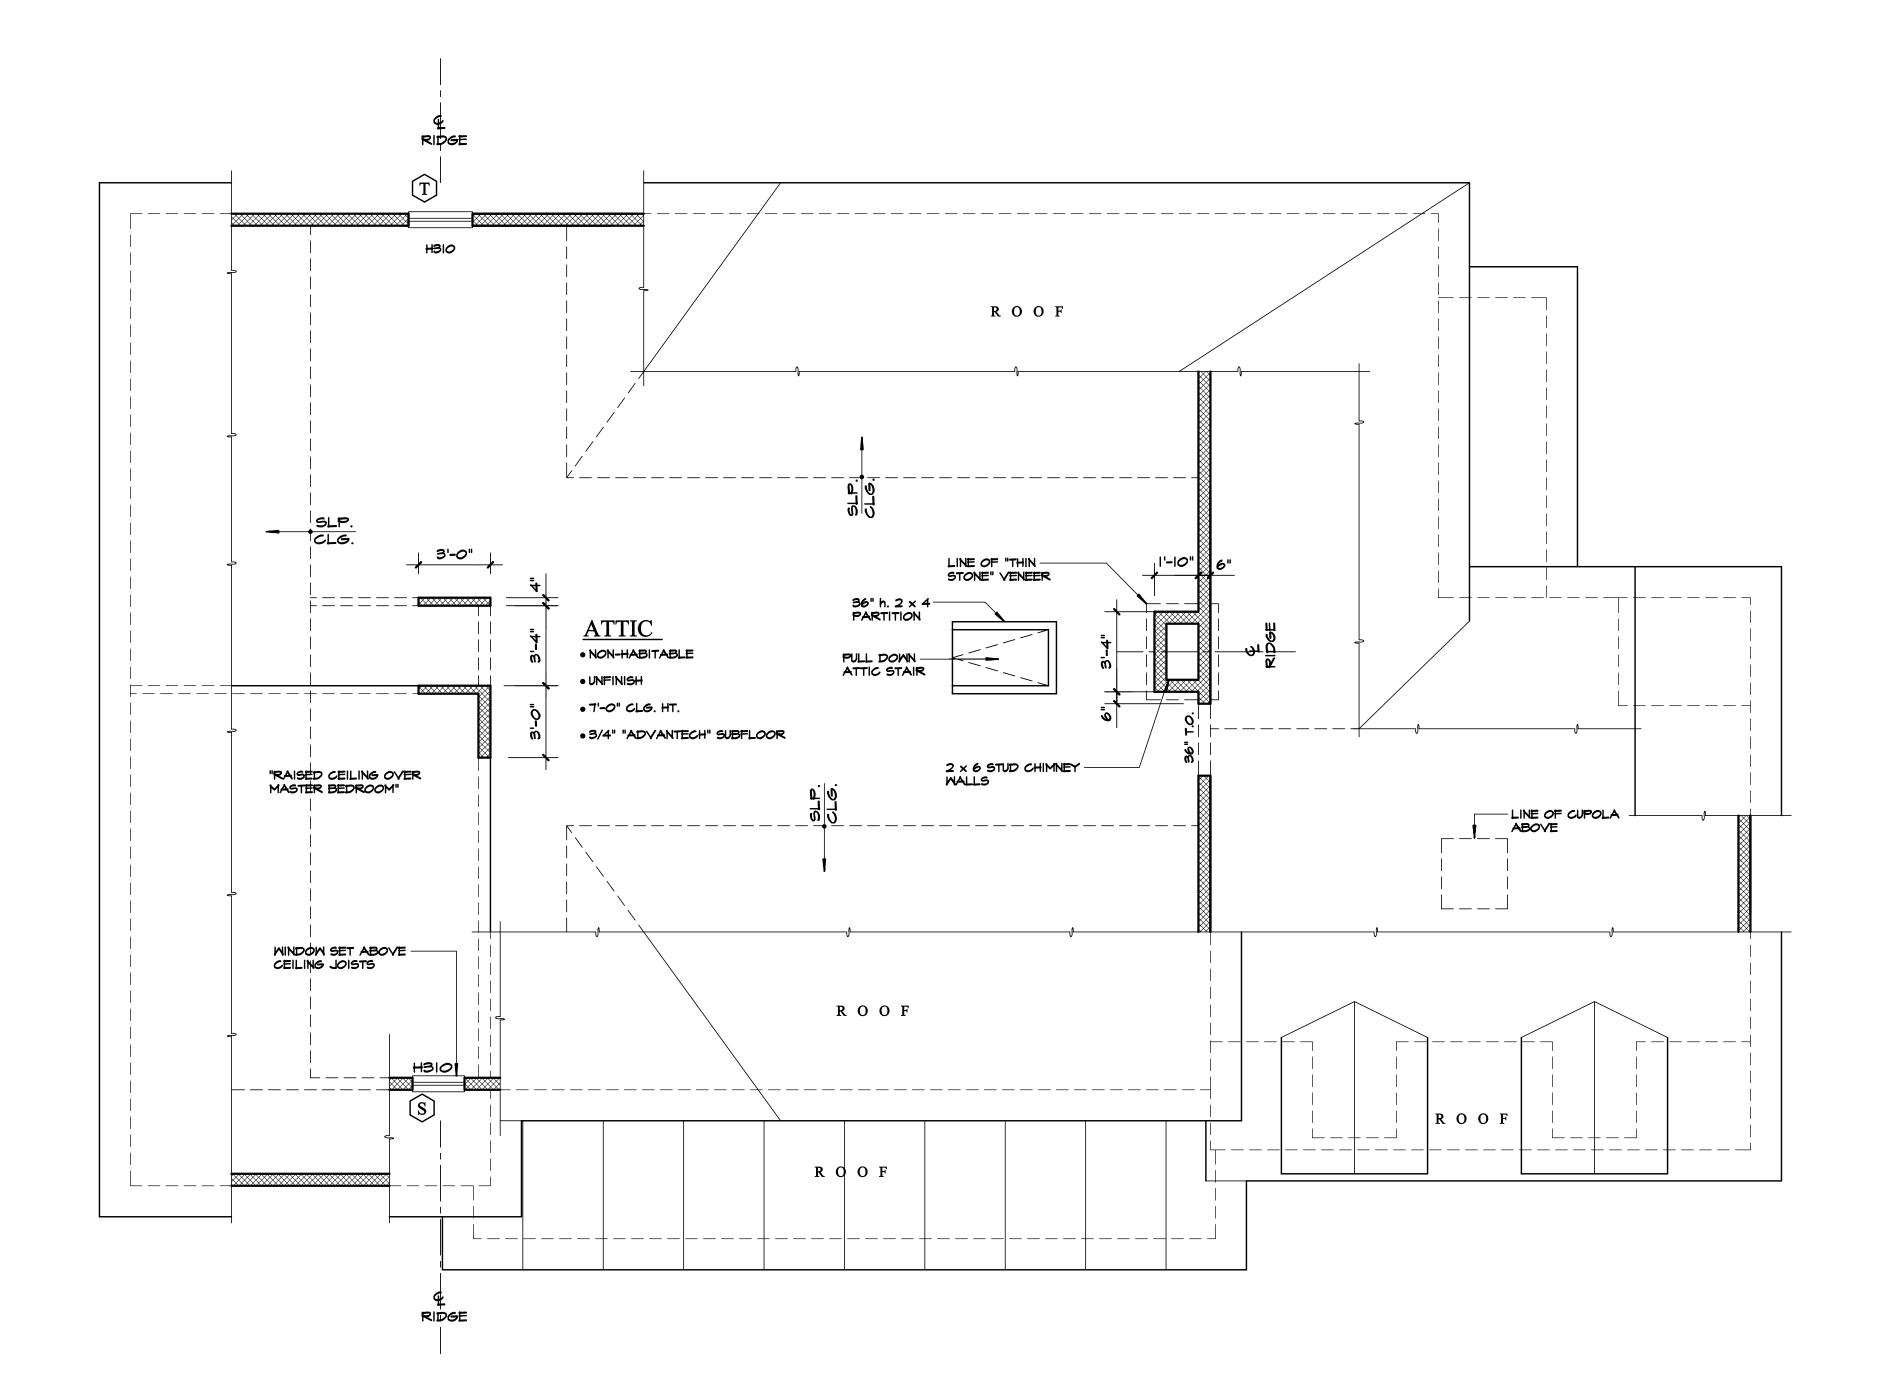

## ATTIC FLOOR PLAN

SCALE: 1/4"= 1'-0"

NOTE: HEADERS AT ALL INTERIOR DOOR & TRIMMED OPENINGS SHALL BE (3)  $2 \times 10$  @  $2 \times 6$  WALLS AND (2)  $2 \times 10$  @  $2 \times 4$  WALLS UNLESS NOTED OTHERWISE

### GENERAL NOTES

- 1. SEE PLANS PREPARED BY DESIGNER FOR KITCHEN CABINET PLUMBING FIXTURE LAYOUT. G.C. SHALL PROVIDE CABINET
- SOFFIT AND APPLIANCE AS REQUIRED.

  2. SEE WINDOW AND DOOR SCHEDULE FOR TYPES.

  3. PROVIDE 16 OZ COPPER SILL PAN ELASHING AT ALL.
- 3. PROVIDE 16 OZ. COPPER SILL PAN FLASHING AT ALL EXTERIOR DOOR ROUGH OPENINGS AND AT WINDOWS IMMEDIATELY ABOVE A ROOF (REVIEW WITH ARCHITECT).
- 4. PROVIDE 15# ASPHALT WRAP AT ALL WINDOW AND DOOR OPENINGS AS PER DETAIL ON WINDOW & DOOR SCHEDULE5. PROVIDE FIREBLOCKING AT ALL SOFFITS AND TUBS.
- FROVIDE FIREBLOCKING AT ALL SOFFITS AND TOBS.
  FLUE CHASES SHALL BE FIREBLOCKED AT EACH FLOOR LEVEL INCLUDING ATTIC.
  INSULATE ALL INTERIOR WALLS THROUGHOUT AS WELL
- AS ENTIRE FLOOR UNDER SECOND FLOOR ROOMS
  W/ UNFACED F.G. BATTS FOR SOUND DEADENING.
  8. PROVIDE 5/8" TYPE-X GYPSUM BOARD THROUGHOUT
- WALLS AND CEILING.
  9. PROVIDE FROST-FREE HOSE BIBS AS NEEDED. REVIEW
- 10. FLOORING IN NON-TILED ROOMS UNLESS NOTED
- OTHERWISE SHALL BE CLEAR GRADE RED OAK, G.C. SHALL SELECT BOARD WIDTH DIMENSION.
- 11. TILE WORK SHALL BE AS PER TCA SPECS (LATEST EDITION).
  12. G.C. SHALL SELECT ALL CABINETRY.
- 13. G.C. SHALL SELECT DOOR HARDWARE.
- 14. PROVIDE TIGHT-FITTING NON-COMBUSTIOUS GLASS DOORS AT EACH FIREPLACE IN CONFORMANCE WITH E102.5 OF THE NYS ENERGY CODE.
- 15. PRIME AND PAINT ALL DRYWALL (3 COATS; 1 PRIME & 2 FINISH). STAIN AND POLYURETHANE ALL OAK WOOD (FURNITURE QUALITY FINISH). REVIEW TYPES AND COLORS WITH OWNER PRIOR TO START OF WORK. SUBMIT SAMPLES TO G.C. FOR REVIEW AND APPROVAL.

### HVAC NOTE

1. REVIEW HEATING AND AIR CONDITIONING
REQUIREMENTS WITH OWNER AND SUBMIT PROPOSED
SYSTEM AND SPECIFICATIONS FOR OWNER'S APPROVAL.

### STAIR & RAILING

SHALL COMPLY WITH 2010 N.Y.S. RESIDENTIAL CODE, SECTION R311 & R312

openen ion & ion	2				
STAIR LOCATION	MAIN	BACK	BASEMENT		
WIDTH	48"	40"	44"		
TREAD	9"	9"	9"		
RISER	7.6" +/-	7.6" +/-	7.6" +/-		
HEADROOM	80" <	80" <			
HANDRAIL GRIP	TYPE 1				
BALUSTER SPACING	LESS THAN 4" O.C.				
HANDRAIL HEIGHT	36"				
GUARDRAIL HEIGHT	42"				

# LEGEND

EXISTING WALL ( VERIFY IN FIELD )

NEW WOOD STUD WALL 2 x @ 16" O.C.

POURED CONCRETE WALL

CMU WALL (CEMENT GROUT SOLID)

STONE VENEER

BRICK VENEER

32 DOOR SIZE (NOTED IN INCHES)

EGRESS WINDOW \*

₩INDOW TYPE \*

₩ HEADER SIZE \*

LINTEL SIZE \*

COPPER SILL PAN

H FROST FREE HOSE BIB

EXHAUST FAN (50 CFM, MIN.)
VENT TO EXTERIOR W/ METAL DUCT
HEAT SENSOR
HARD WIRED W/ BATTERY BACKUP (U.L. LISTED)

INTERCONNECTED, NFPA 72 COMPLIANCE

SMOKE ALARM
HARD WIRED W/ BATTERY BACKUP (U.L. LISTED)
INTERCONNECTED, NFPA 72 COMPLIANCE

NUMBER OF STUDS (MULL OR JACK)

CARBON MONOXIDE ALARM
HARD WIRED W/ BATTERY BACKUP (U. L. LISTED)
INTERCONNECTED, NFPA 72 COMPLIANCE

\* REFER TO WINDOW & DOOR SCHEDULE SHEET FOR SCHEDULES AND SPECIFICATIONS

DO NOT SCALE PRINTS

ARCH 101

Proposed Residence

23 Shawnee

Road, LLC

23 Shawnee Road

Scarsdale N.Y.

WESTCHESTER • NEW YORK

DATE: 03/15/16


REVISIONS: 04/25/16

ARCHITECT'S SEAL

DWG No.

ATTIC FLOO

ATTIC FLOOR
23 shawnee rd/216002

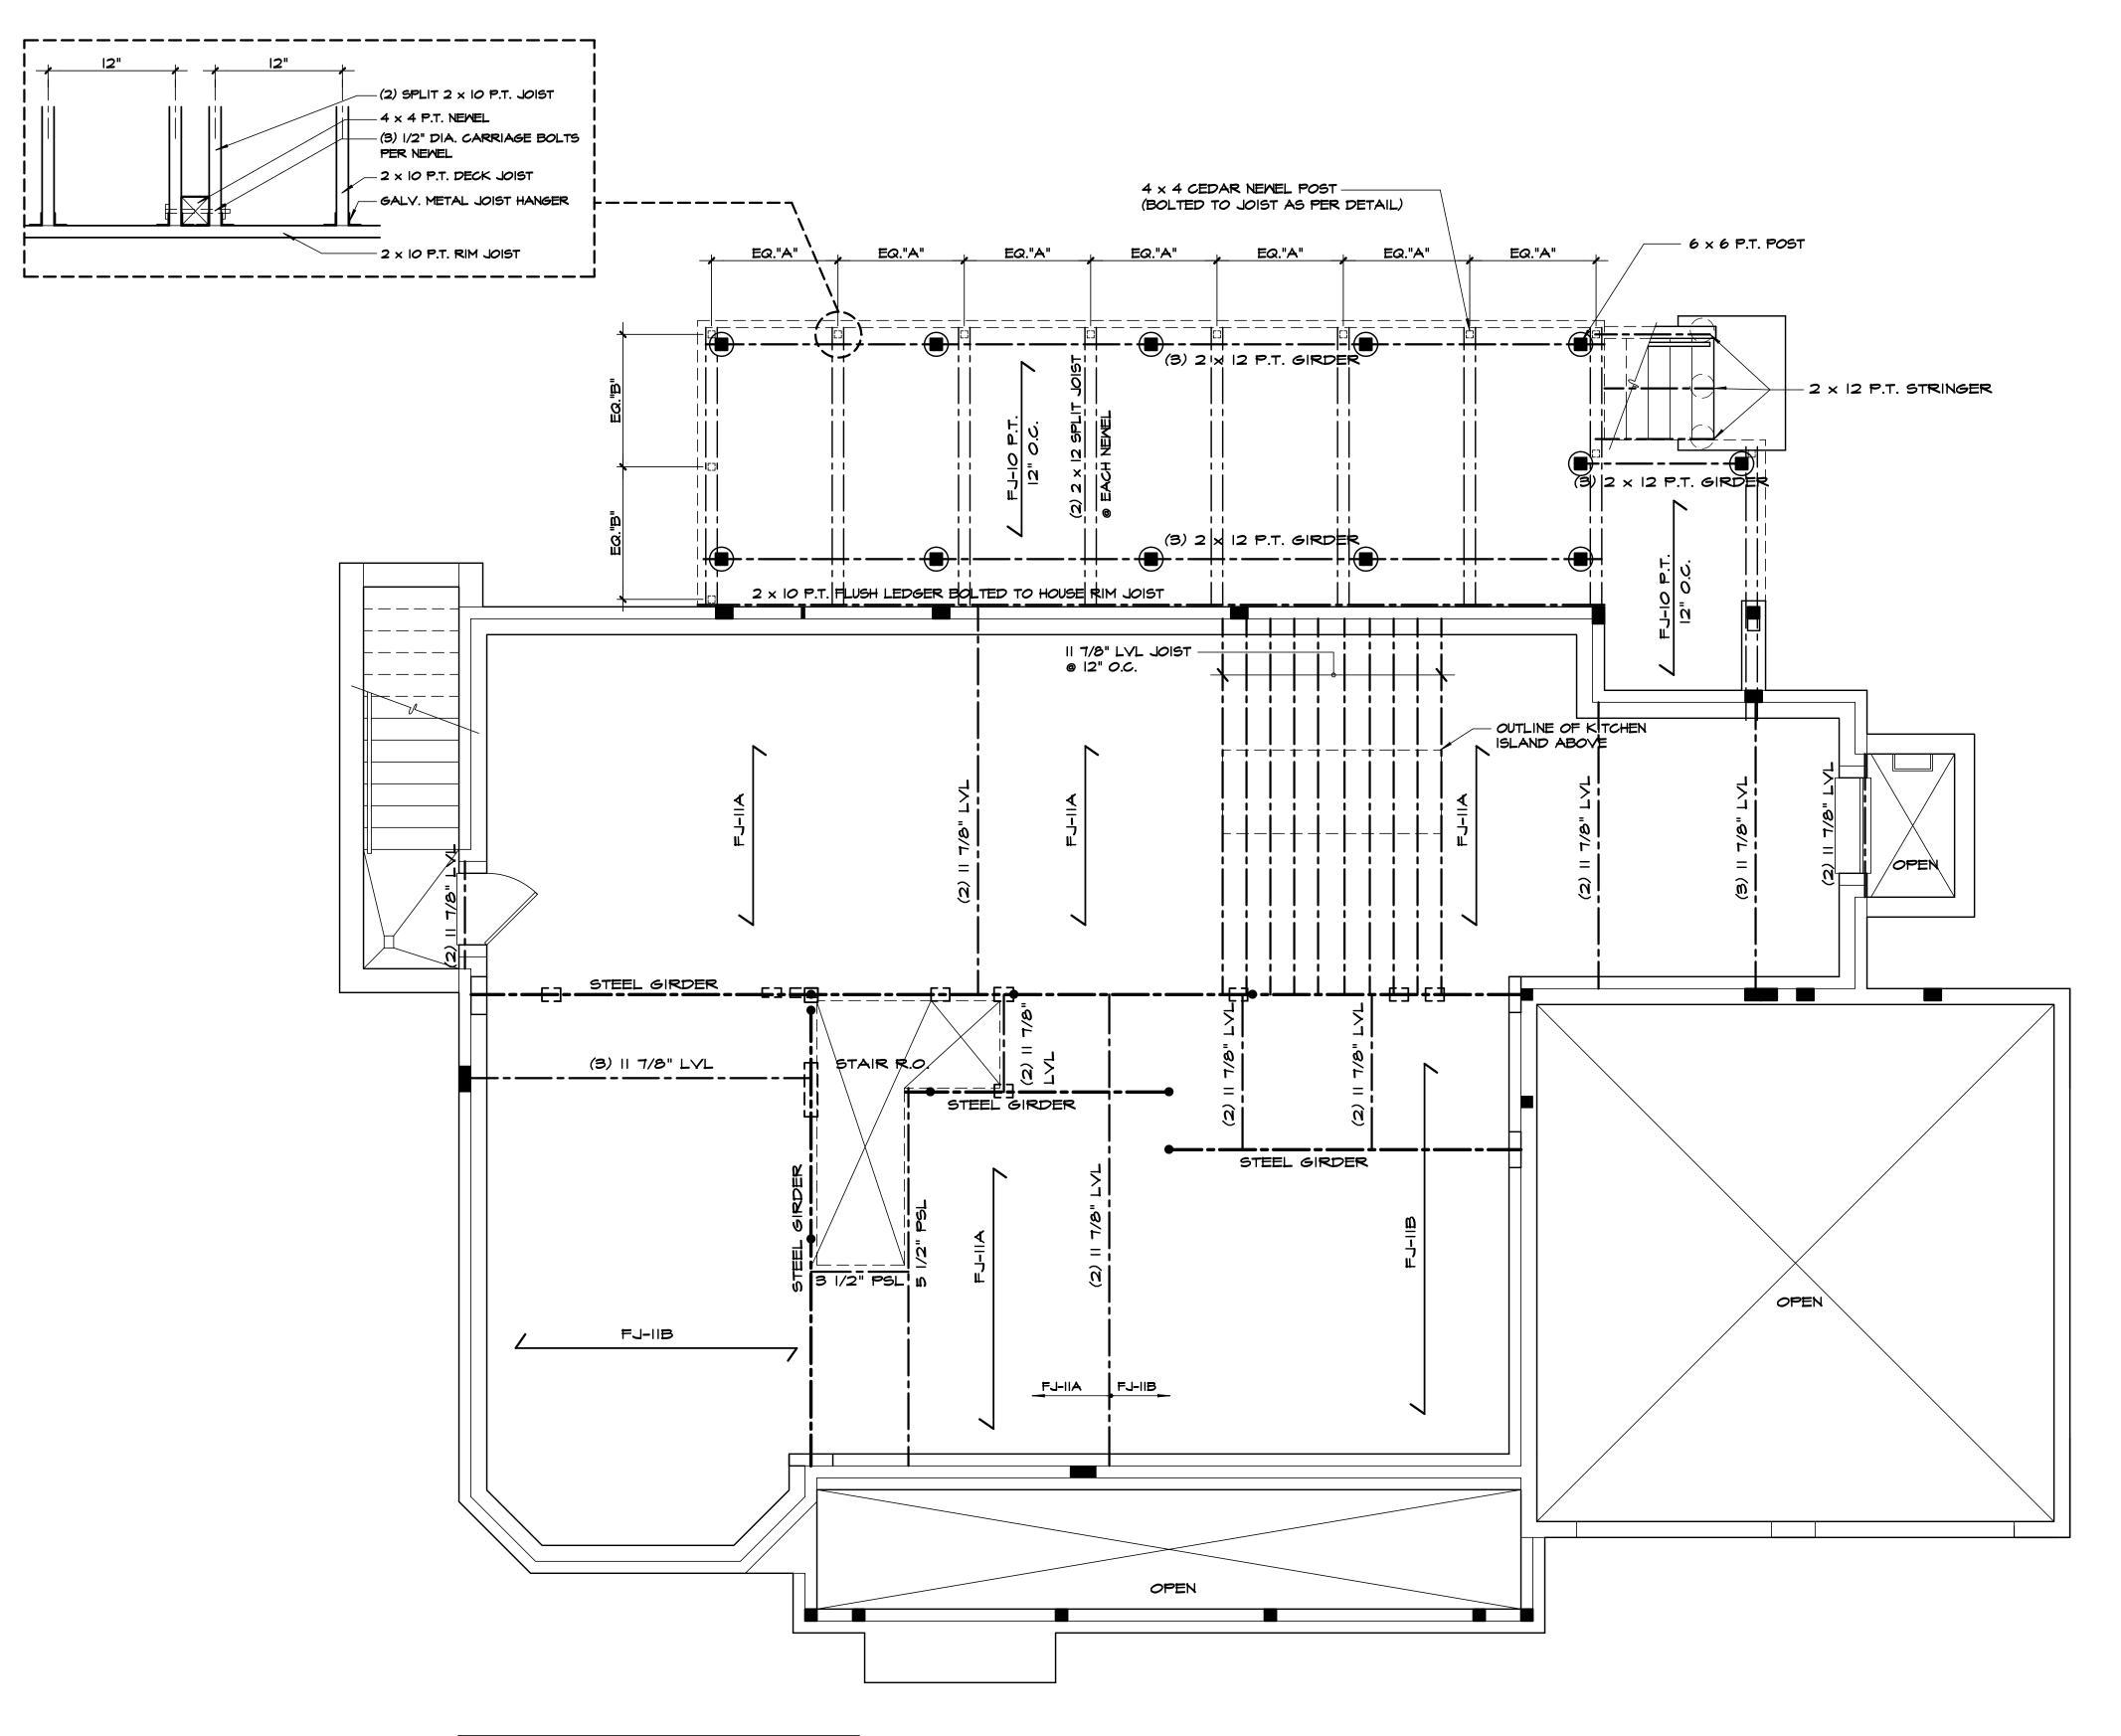


G.C. SHALL LAYOUT PLUMBING FIXTURES PRIOR TO FLOOR FRAMING TO MINIMIZE NEED FOR JOIST HEADERS AT PLUMBING WASTE LINES.

### FIRST FLOOR FRAMING LAYOUT SCALE: 1/4"= 1'-0"

- BASEMENT FLOOR PLAN • PSL BEAMS (WHERE SHOWN ON PLAN) SHALL NOT BE SUBSTITUTED WITH A BUILT-UP LVL BEAM.
- ALL FRAMING MEMBERS SHOWN ARE FLUSH W/ FLOOR OR ROOF PLANE (CONNECTED WITH METAL HANGERS) UNLESS OTHERWISE NOTED OR DESIGNATED AS A HEADER WHICH THEN THE MEMBER IS SET BELOW THE PLANE.
- SOLID BRIDGING @ MID-SPAN

### . ALL MUDSILL PLATES SHALL BE PRESSURE TREATED DOUBLE 2 x 6. Proposed Residence 2. ALL STEEL, INCLUDING BEARING PLATES SHALL BE SHOP PRIMED AND RECEIVE A SECOND COAT IN THE FIELD UPON COMPLETION. 3. TOP FLANGE OF STEEL GIRDERS TO BE FLUSH WITH TOP OF FOUNDATION WALL, UNLESS NOTED OTHERWISE. 4. COLUMNS TO BE STANDARD STEEL PIPE. 23 Shawnee 5. STEEL SHALL HAVE PRE-DRILLED HOLES FOR 1/2 IN. DIA. BOLTS. TOP FLANGE OF STEEL GIRDERS SHALL HAVE 2 ROWS @ 24-IN. O.C. 5. PROVIDE SOLID BRIDGING @ MID-POINT OF FLOOR SPANS GREATER THAN 8 ft Road, LLC SUBFLOOR SHALL BE GLUED AND NAILED TO FLOOR JOIST W/ CONTECH PL400. PROVIDE GALVANIZED METAL JOIST HANGERS AT ALL FLUSH CONNECTIONS. BLOCKING AS REQUIRED ) TO FOUNDATION WALLS, PIERS, OR STEEL GIRDERS 10. ALL EXTERIOR METAL ANCHORS, FASTENERS, BOLTS, ETC.....SHALL BE HOT DRIPPED GALVANIZED STEEL. 11. PROVIDE 2 x FIRESTOPPING AT DROP CEILINGS AND WHERE REQUIRED BY 23 Shawnee Road CODE. REVIEW WITH LOCAL BUILDING OFFICIALS. 12. PROVIDE HURRICANE TIE AT EACH RAFTER; SIMPSON # H2.5A. Scarsdale N.Y. 13. STEP ROOF SHEATHING BACK FROM RIDGE AS REQUIRED FOR RIDGE VENTS WALL BRACING WALL BRACING BE IN ACCORDANCE WITH METHOD 3 (SECTION 602.10.3) AND IN COMPLIANCE AS PER TABLE 602.10.1 OF THE RESIDENTIAL CODE OF NYS. SHEATHING SUBFLOOR: 3/4" ADVANTECH 1/2" EXTERIOR GRADE PLYWOOD 5/8" EXTERIOR GRADE PLYWOOD LEGEND FLOOR I-JOIST, LVL & PSL SHALL BE MANUFACTURED BY TRUS JOIST WEYERHAEUSER OR APPROVED EQUAL. G.C. SHALL BE RESPONSIBLE TO SUBMIT SPECIFICATIONS FOR SUBSTITUTED MANUFACTURER TO ARCHITECT FOR REVIEW PRIOR TO MATERIAL ORDER. L.V.L. LAMINATED VENEER LUMBER 1.9 E (Fb = 2,600 PSI)P.S.L. PARALLEL STRAND LUMBER 2.0 E (Fb = 2,900 PSI)D.F. DIMENSIONAL FRAMING LUMBER NO. 2 DOUGLAS FIR (Fb = 950 PSI) P.T. PRESSURE TREATED LUMBER NO. 1 S.Y.P. (Fb = 1050 PSI) A= 560 SERIES | B= 360 SERIES C= 230 SERIES FLOOR JOIST SPACING IS 16" ON - CENTER UNLESS OTHERWISE NOTED ON THE FRAMING LAYOUT FJ-5 5 1/2" LVL FJ-6 \ $2 \times 6$ D.F. FJ-7 7 1/4" LVL 6-L7 $2 \times 8$ D.F. 9 1/2" TJI FJ-9L \ 9 1/4" or 9 1/2" LVL \* FJ-10 \ $2 \times 10$ D.F. 11 7/8" TJI FJ-IIL 11 1/4" or 11 7/8" LVL \* FJ-I2 \ $2 \times 12$ D.F. FJ-14 14" TJI FJ-16 \ \* MATCH DEPTH OF EXISTING JOIST, TRIM NEW JOIST AS REQUIRED. CEILING JOIST SPACING IS 16" ON - CENTER UNLESS OTHERWISE NOTED ON THE FRAMING LAYOUT $2 \times 6$ D.F. CJ-7 \ 7 1/4" LVL $2 \times 8$ D.F. 9 1/2" LVL $2 \times 10$ D.F. 11 7/8" LVL $2 \times 12$ D.F. $2 \times 6$ D.F. SLOPED ROOF RAFTER SPACING IS 16" ON-CENTER UNLESS OTHERWISE NOTED ON THE FRAMING LAYOUT **R-6** \ \ 2 x 6 D.F. $2 \times 8$ D.F. **R-9** \ 9 1/2" LVL R-10 \ 2 x 10 D.F. ARCH 101 11 7/8" LVL R-12 $2 \times 12 \text{ D.F.}$ WESTCHESTER • NEW YORK R-14 14" LVL ROOF PITCH 03/15/16 INTERIOR BEARING WALL REVISIONS: BUILT-UP 2 x POST CONTINUOUS DOWN TO FOUNDATION WALL OR GIRDER 04/25/16 ( MINIMUM POST WIDTH SHALL BE THE BEAM WIDTH PLUS 2 STUDS) QUANTITY OF BUILT-UP STUD POST ARCHITECT'S SEAL BUILT-UP POST ABOVE ON BEAM CEILING HEIGHT (ROUGH FRAMING) DO NOT SCALE PRINTS

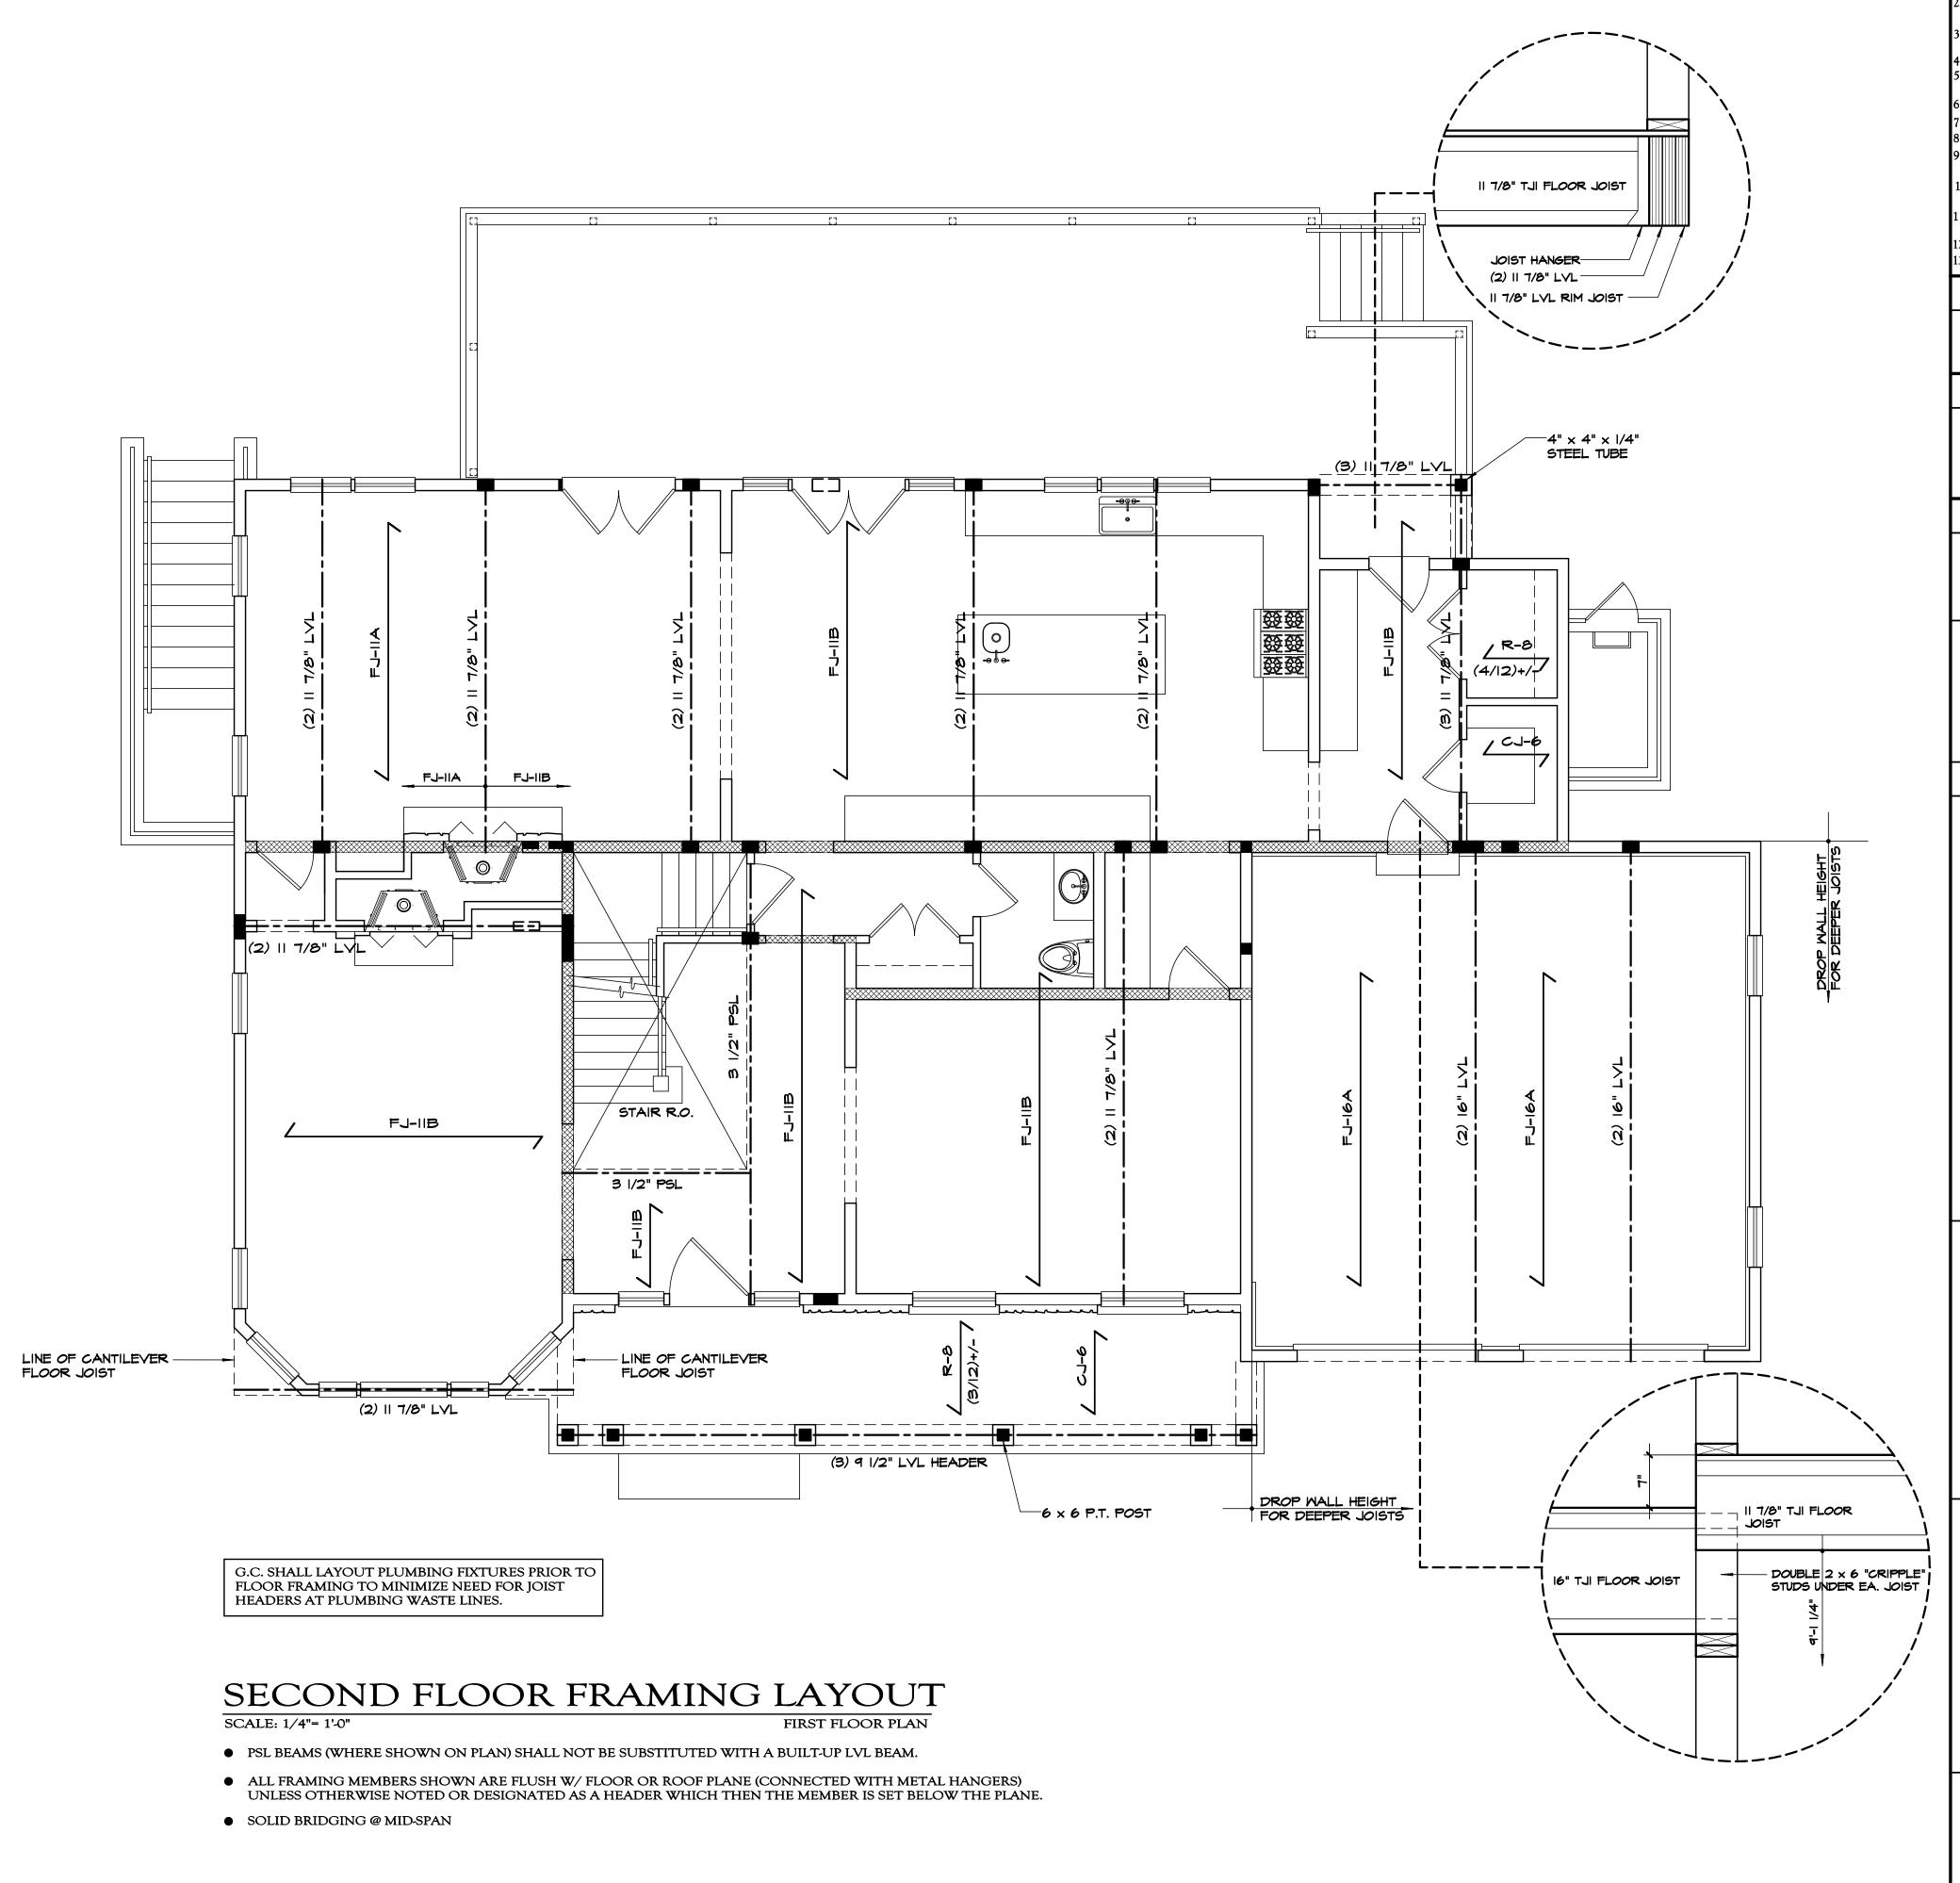


### GENERAL NOTES . ALL MUDSILL PLATES SHALL BE PRESSURE TREATED DOUBLE $2\times6$ . Proposed Residence 2. ALL STEEL, INCLUDING BEARING PLATES SHALL BE SHOP PRIMED AND RECEIVE A SECOND COAT IN THE FIELD UPON COMPLETION. 3. TOP FLANGE OF STEEL GIRDERS TO BE FLUSH WITH TOP OF FOUNDATION WALL, UNLESS NOTED OTHERWISE. 4. COLUMNS TO BE STANDARD STEEL PIPE. 23 Shawnee 5. STEEL SHALL HAVE PRE-DRILLED HOLES FOR 1/2-IN. DIA. BOLTS. TOP FLANGE OF STEEL GIRDERS SHALL HAVE 2 ROWS @ 24-IN. O.C. 6. PROVIDE SOLID BRIDGING @ MID-POINT OF FLOOR SPANS GREATER THAN 8 ft Road, LLC SUBFLOOR SHALL BE GLUED AND NAILED TO FLOOR JOIST W/ CONTECH PL400. PROVIDE GALVANIZED METAL JOIST HANGERS AT ALL FLUSH CONNECTIONS. ALL SOLID AND BUILT-UP WOOD POSTS SHALL BE CONTINUOUS (W/SOLID BLOCKING AS REQUIRED ) TO FOUNDATION WALLS, PIERS, OR STEEL GIRDERS 10. ALL EXTERIOR METAL ANCHORS, FASTENERS, BOLTS, ETC.....SHALL BE HOT DRIPPED GALVANIZED STEEL. 11. PROVIDE 2 x FIRESTOPPING AT DROP CEILINGS AND WHERE REQUIRED BY 23 Shawnee Road CODE. REVIEW WITH LOCAL BUILDING OFFICIALS. 12. PROVIDE HURRICANE TIE AT EACH RAFTER; SIMPSON # H2.5A. Scarsdale N.Y. 13. STEP ROOF SHEATHING BACK FROM RIDGE AS REQUIRED FOR RIDGE VENTS WALL BRACING WALL BRACING BE IN ACCORDANCE WITH METHOD 3 (SECTION 602.10.3) AND IN COMPLIANCE AS PER TABLE 602.10.1 OF THE RESIDENTIAL CODE OF NYS. SHEATHING SUBFLOOR: 3/4" ADVANTECH 1/2" EXTERIOR GRADE PLYWOOD 5/8" EXTERIOR GRADE PLYWOOD LEGEND FLOOR I-JOIST, LVL & PSL SHALL BE MANUFACTURED BY TRUS JOIST WEYERHAEUSER OR APPROVED EQUAL. G.C. SHALL BE RESPONSIBLE TO SUBMIT SPECIFICATIONS FOR SUBSTITUTED MANUFACTURER TO ARCHITECT FOR REVIEW PRIOR TO MATERIAL ORDER. L.V.L. LAMINATED VENEER LUMBER 1.9 E (Fb = 2,600 PSI)P.S.L. PARALLEL STRAND LUMBER 2.0 E (Fb = 2,900 PSI)D.F. DIMENSIONAL FRAMING LUMBER NO. 2 DOUGLAS FIR (Fb = 950 PSI) P.T. PRESSURE TREATED LUMBER NO. 1 S.Y.P. (Fb = 1050 PSI) A= 560 SERIES | B= 360 SERIES C= 230 SERIES FLOOR JOIST SPACING IS 16" ON - CENTER UNLESS OTHERWISE NOTED ON THE FRAMING LAYOUT 5 1/2" LVL FJ-6 \ $2 \times 6$ D.F. 7 1/4" LVL 2 x 8 D.F. 9 1/2" TJI FJ-9L \ 9 1/4" or 9 1/2" LVL \* FJ-10 \ $2 \times 10$ D.F. 11 7/8" TJI 11 1/4" or 11 7/8" LVL \* FJ-12 \ $2 \times 12$ D.F. FJ-14 14" TJI FJ-16 \ \* MATCH DEPTH OF EXISTING JOIST, TRIM NEW JOIST AS REQUIRED. CEILING JOIST SPACING IS 16" ON - CENTER UNLESS OTHERWISE NOTED ON THE FRAMING LAYOUT $2 \times 6$ D.F. 7-LO 7 1/4" LVL $2 \times 8$ D.F. 9 1/2" LVL $2 \times 10$ D.F. 11 7/8" LVL $2 \times 12$ D.F. $2 \times 6$ D.F. SLOPED ROOF RAFTER SPACING IS 16" ON-CENTER UNLESS OTHERWISE NOTED ON THE FRAMING LAYOUT **R-6** \ 2 x 6 D.F. $2 \times 8$ D.F. **R-9** \ 9 1/2" LVL ARCH 101 $2 \times 10$ D.F. 11 7/8" LVL R-12 \ $2 \times 12$ D.F. WESTCHESTER • NEW YORK 14" LVL **ROOF PITCH** 03/15/16 INTERIOR BEARING WALL REVISIONS: BUILT-UP 2 x POST CONTINUOUS DOWN TO FOUNDATION WALL OR GIRDER 04/25/16 ( MINIMUM POST WIDTH SHALL BE THE BEAM WIDTH PLUS 2 STUDS) QUANTITY OF BUILT-UP STUD POST RCHITECT'S SEAL

BUILT-UP POST ABOVE ON BEAM

DO NOT SCALE PRINTS

CEILING HEIGHT (ROUGH FRAMING)

FRAMING LAYOUT

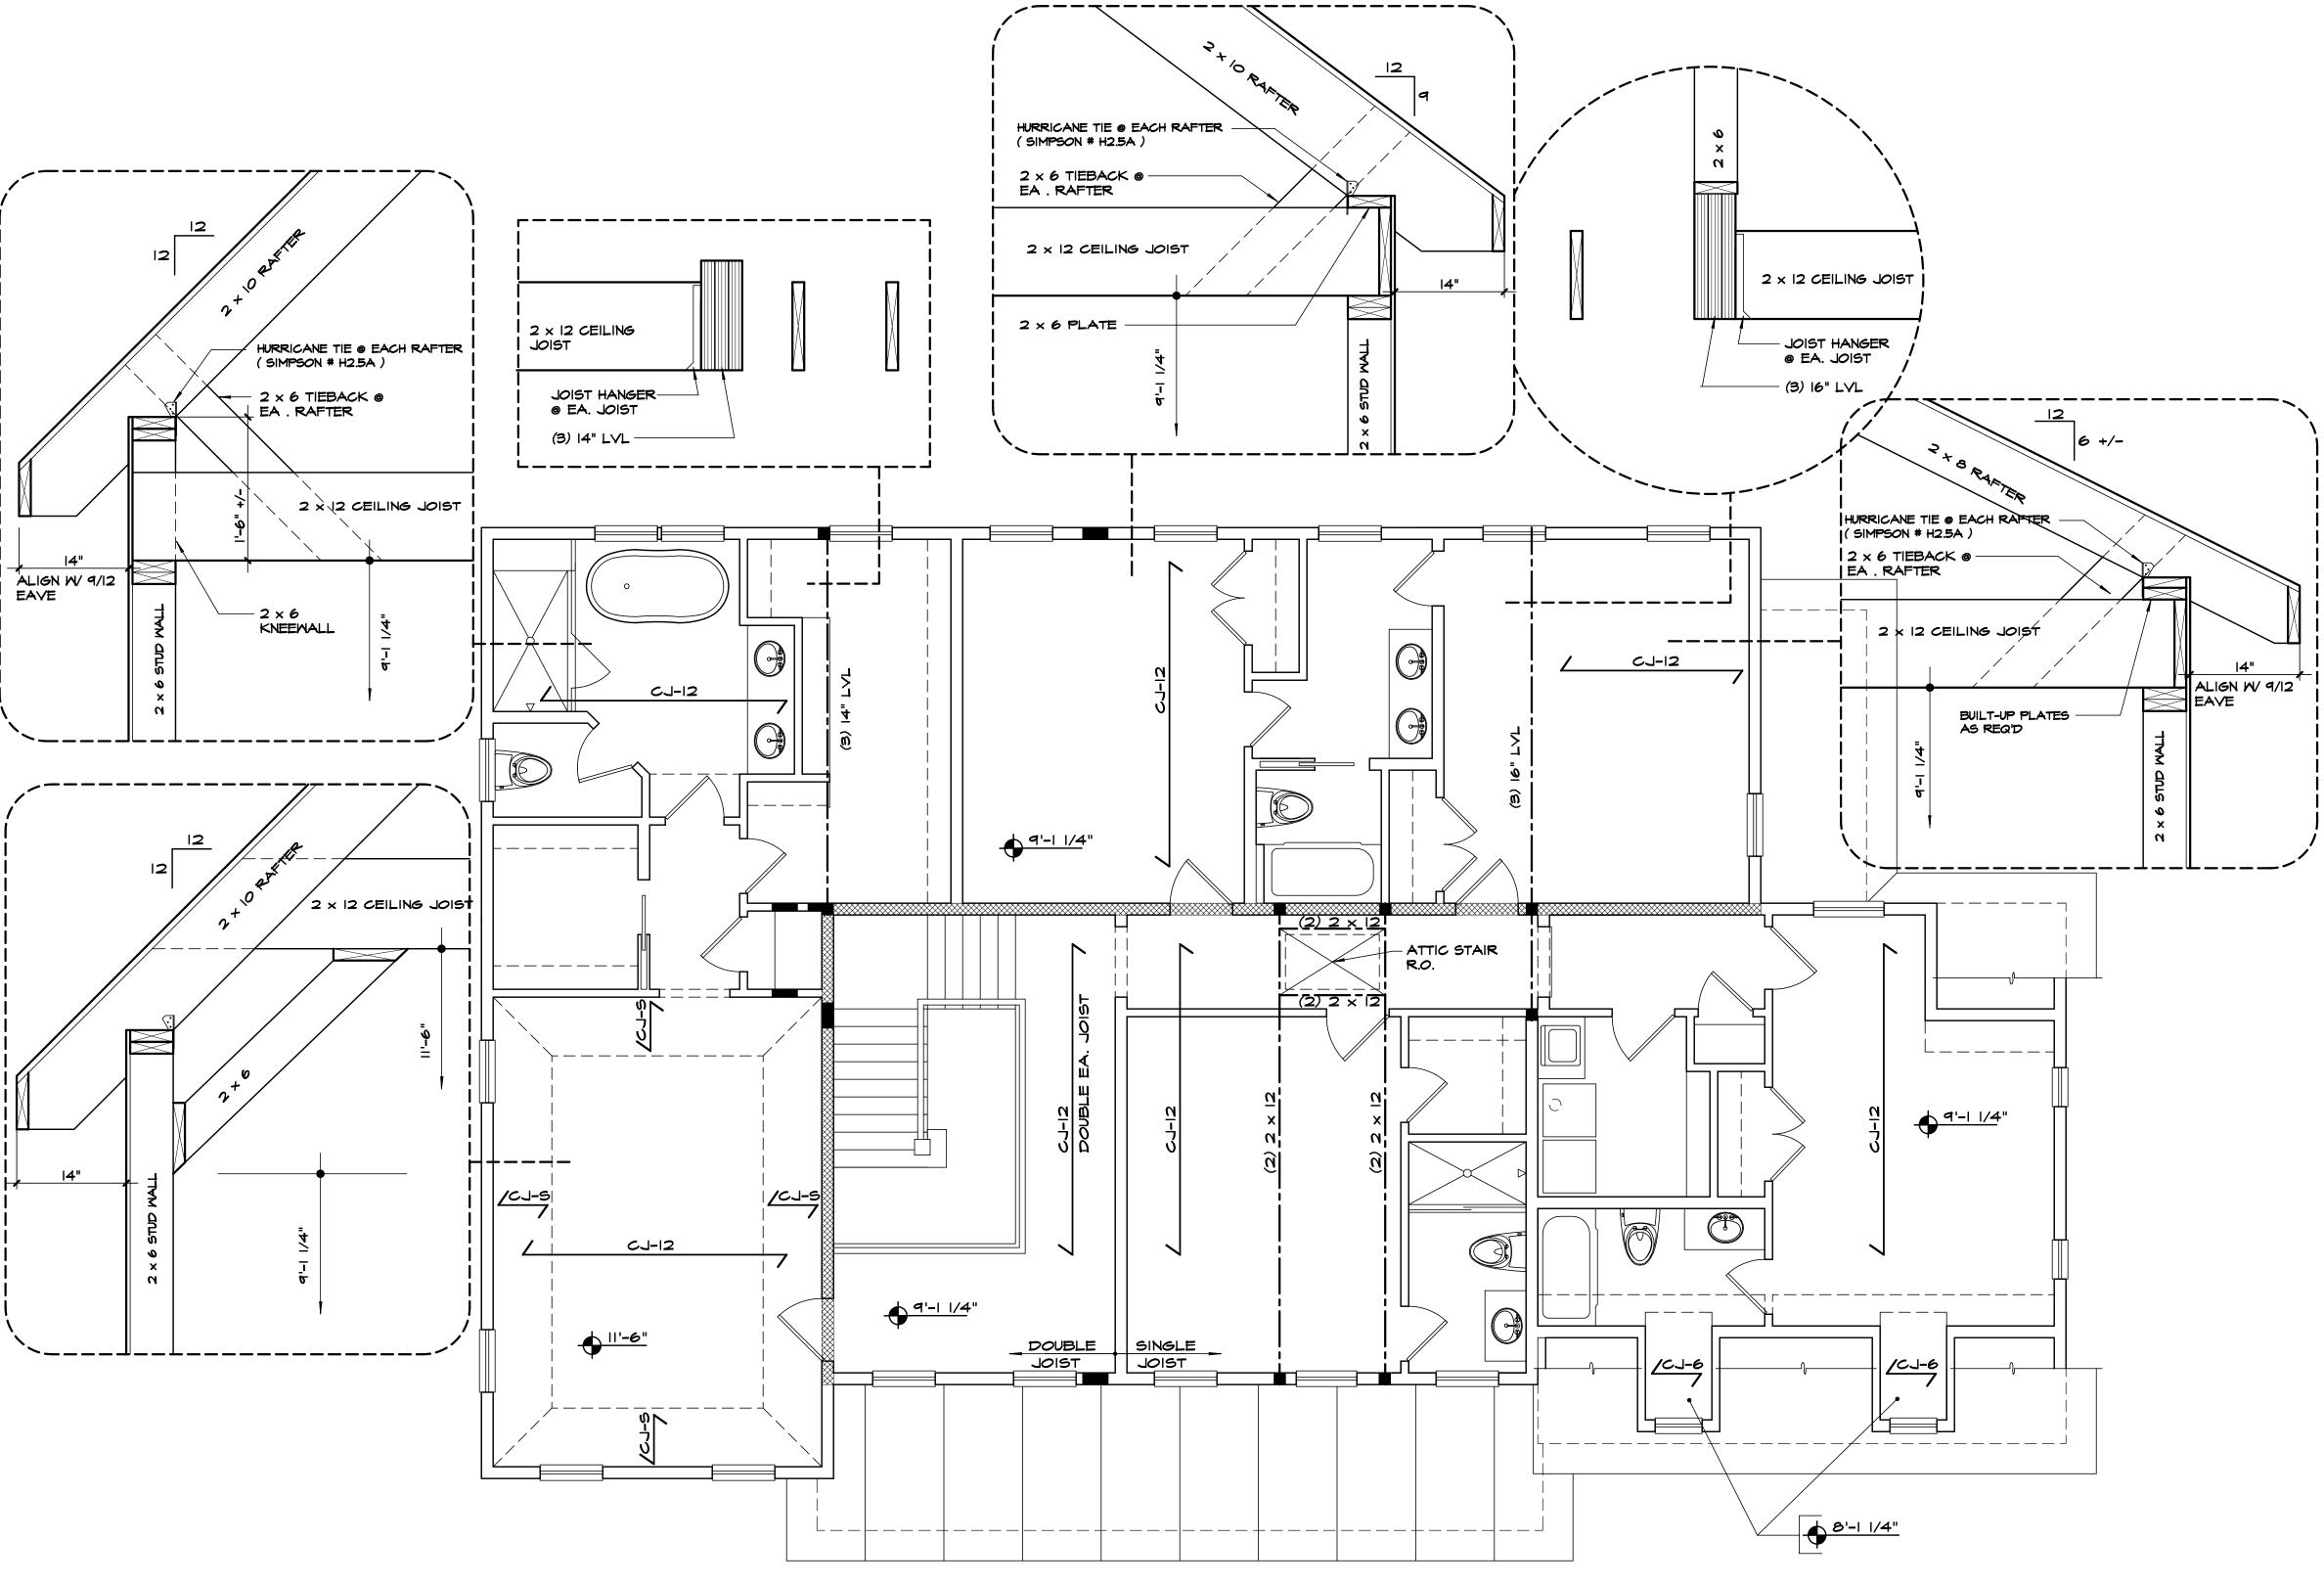



### CEILING FRAMING LAYOUT

SCALE: 1/4"= 1'-0"

SECOND FLOOR PLAN

- PSL BEAMS (WHERE SHOWN ON PLAN) SHALL NOT BE SUBSTITUTED WITH A BUILT-UP LVL BEAM.
- ALL FRAMING MEMBERS SHOWN ARE FLUSH W/ FLOOR OR ROOF PLANE (CONNECTED WITH METAL HANGERS) UNLESS OTHERWISE NOTED OR DESIGNATED AS A HEADER WHICH THEN THE MEMBER IS SET BELOW THE PLANE.
- SOLID BRIDGING @ MID-SPAN

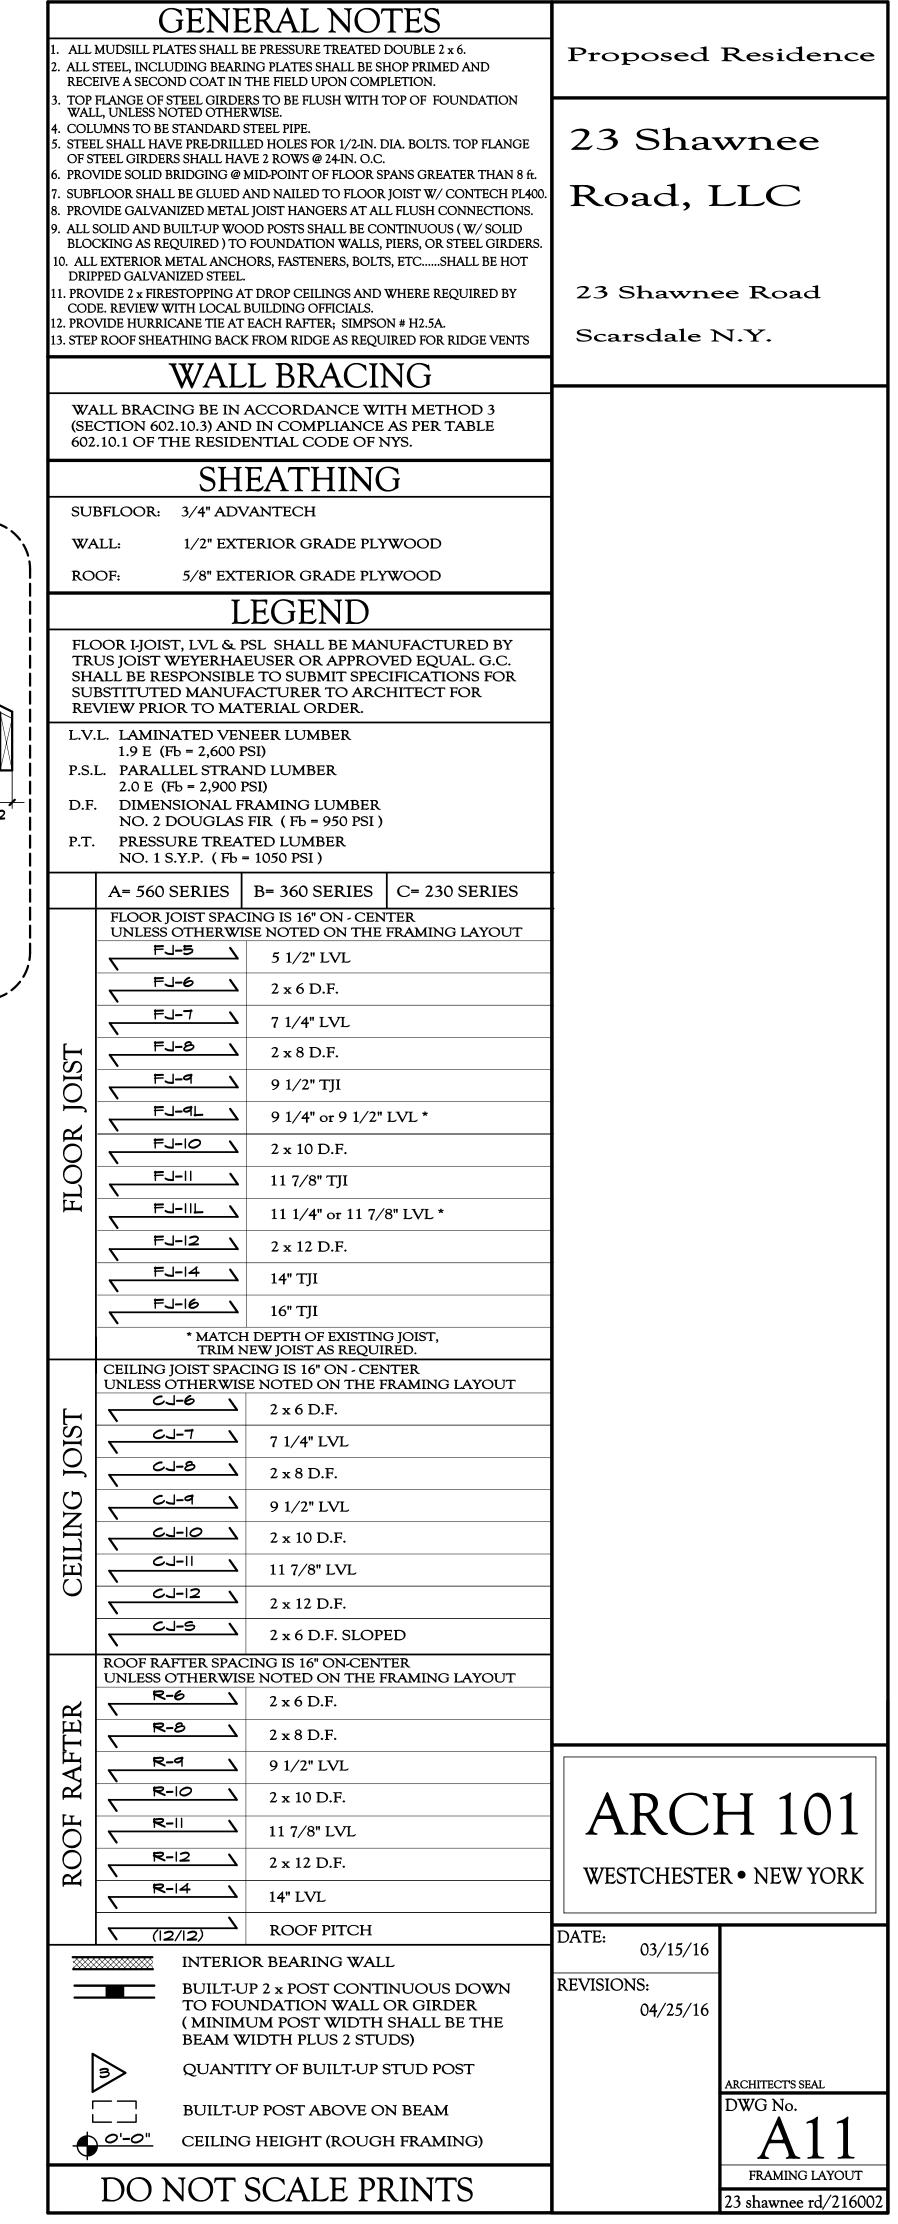

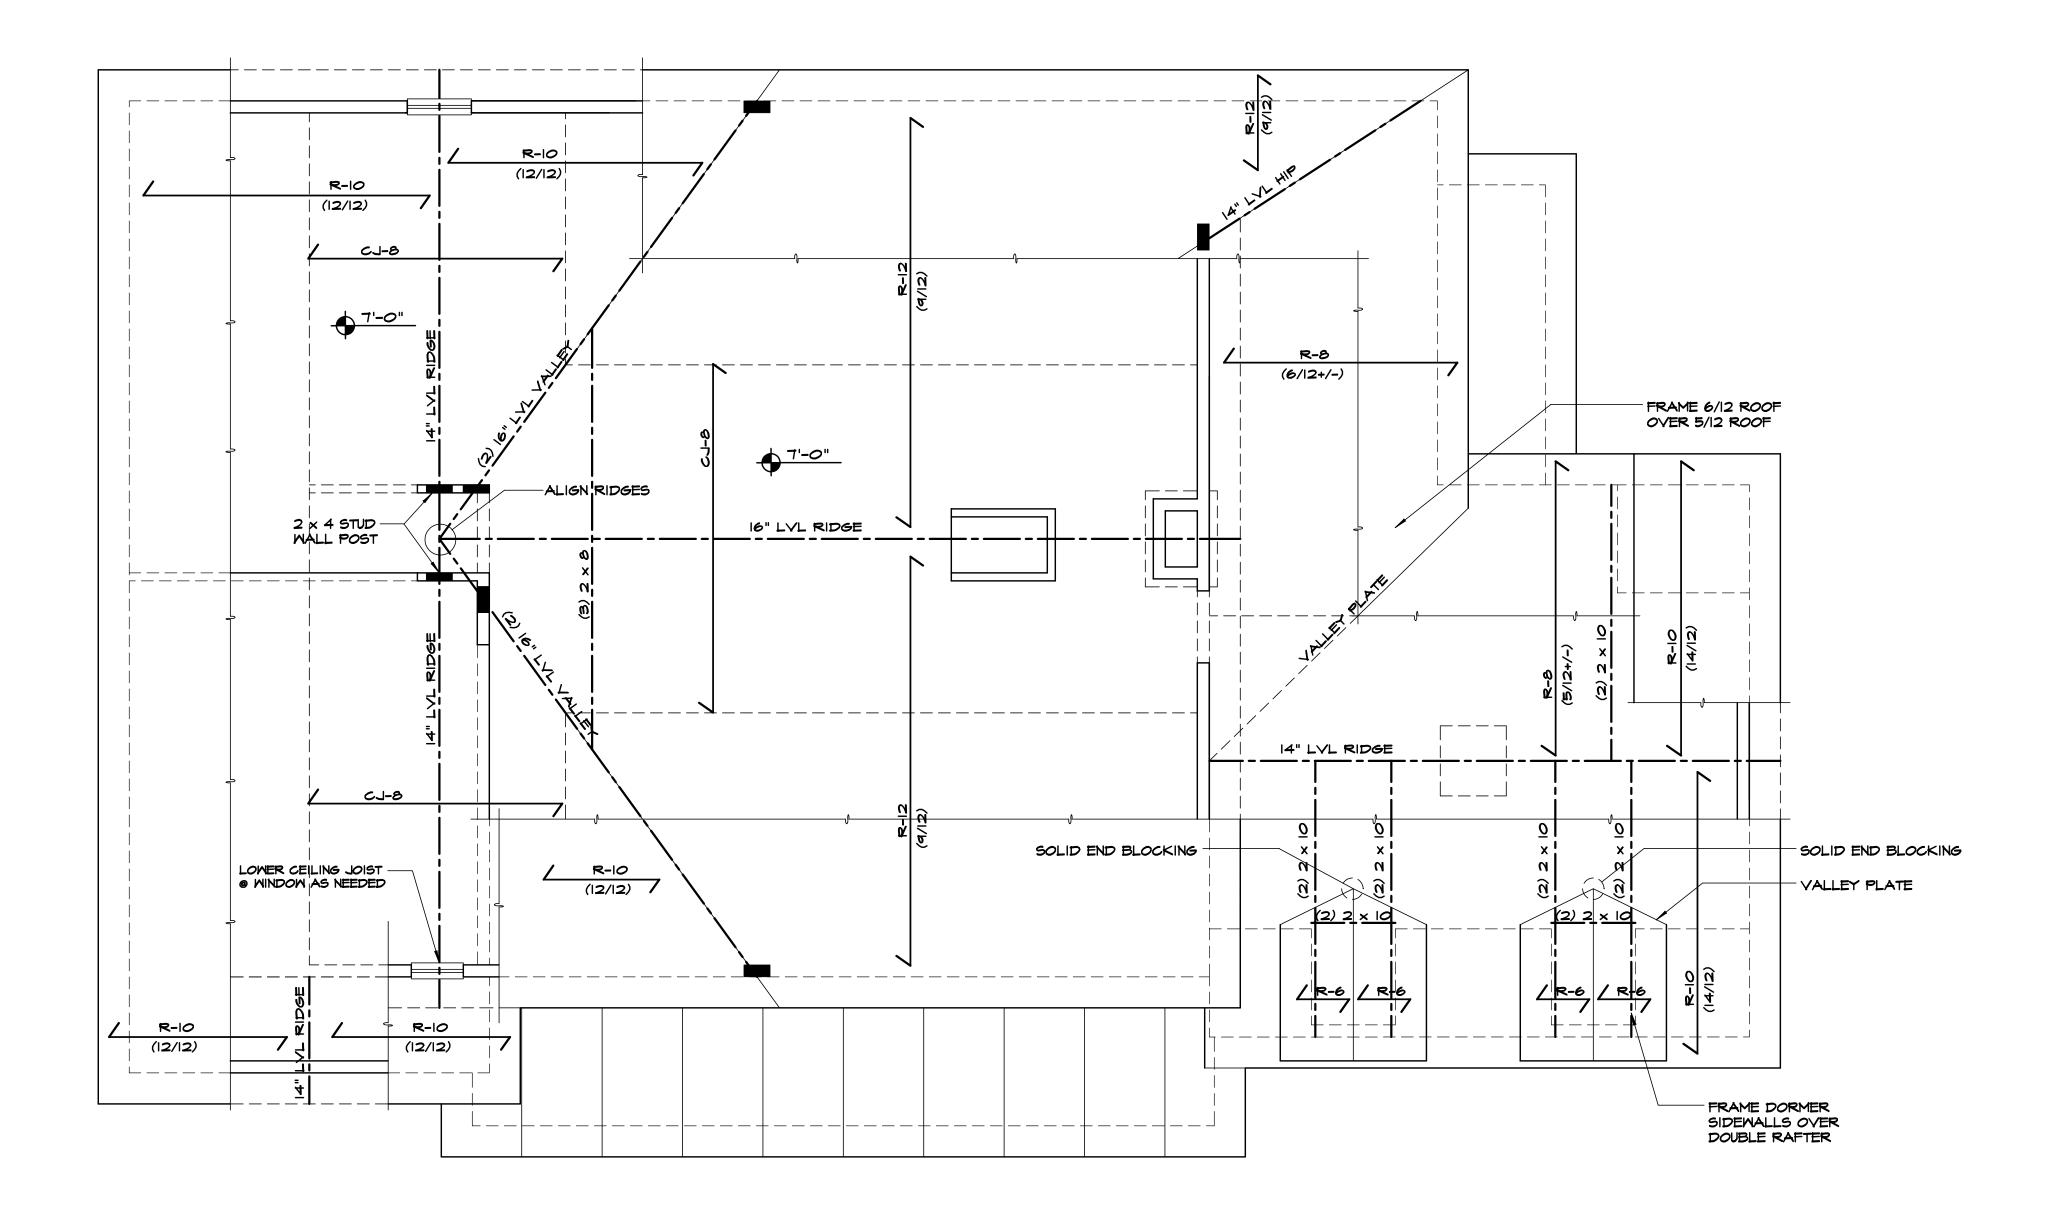


### ROOF FRAMING LAYOUT SCALE: 1/4"= 1'-0" ATTIC FLOOR PLAN

- PSL BEAMS (WHERE SHOWN ON PLAN) SHALL NOT BE SUBSTITUTED WITH A BUILT-UP LVL BEAM.
- ALL FRAMING MEMBERS SHOWN ARE FLUSH W/ FLOOR OR ROOF PLANE (CONNECTED WITH METAL HANGERS) UNLESS OTHERWISE NOTED OR DESIGNATED AS A HEADER WHICH THEN THE MEMBER IS SET BELOW THE PLANE.
- SOLID BRIDGING @ MID-SPAN

UPLIFT CONNECTION CAPACITY TABLE R802.11						
REQUIRED 526 LBS						
PROVIDED 600 LBS						
SIMPSON # H 2.5A HURRICANE TIE						

### GENERAL NOTES . ALL MUDSILL PLATES SHALL BE PRESSURE TREATED DOUBLE 2 x 6. Proposed Residence 2. ALL STEEL, INCLUDING BEARING PLATES SHALL BE SHOP PRIMED AND RECEIVE A SECOND COAT IN THE FIELD UPON COMPLETION. 3. TOP FLANGE OF STEEL GIRDERS TO BE FLUSH WITH TOP OF FOUNDATION WALL, UNLESS NOTED OTHERWISE. 4. COLUMNS TO BE STANDARD STEEL PIPE. 23 Shawnee 5. STEEL SHALL HAVE PRE-DRILLED HOLES FOR 1/2-IN. DIA. BOLTS. TOP FLANGE OF STEEL GIRDERS SHALL HAVE 2 ROWS @ 24-IN. O.C. 6. PROVIDE SOLID BRIDGING @ MID-POINT OF FLOOR SPANS GREATER THAN 8 ft Road, LLC . SUBFLOOR SHALL BE GLUED AND NAILED TO FLOOR JOIST W/ CONTECH PL400. 3. PROVIDE GALVANIZED METAL JOIST HANGERS AT ALL FLUSH CONNECTIONS. ALL SOLID AND BUILT-UP WOOD POSTS SHALL BE CONTINUOUS ( W/ SOLID BLOCKING AS REQUIRED ) TO FOUNDATION WALLS, PIERS, OR STEEL GIRDERS 10. ALL EXTERIOR METAL ANCHORS, FASTENERS, BOLTS, ETC.....SHALL BE HOT DRIPPED GALVANIZED STEEL. 11. PROVIDE 2 x FIRESTOPPING AT DROP CEILINGS AND WHERE REQUIRED BY 23 Shawnee Road CODE. REVIEW WITH LOCAL BUILDING OFFICIALS. 12. PROVIDE HURRICANE TIE AT EACH RAFTER; SIMPSON # H2.5A. Scarsdale N.Y. 13. STEP ROOF SHEATHING BACK FROM RIDGE AS REQUIRED FOR RIDGE VENTS WALL BRACING WALL BRACING BE IN ACCORDANCE WITH METHOD 3 (SECTION 602.10.3) AND IN COMPLIANCE AS PER TABLE 602.10.1 OF THE RESIDENTIAL CODE OF NYS. SHEATHING SUBFLOOR: 3/4" ADVANTECH 1/2" EXTERIOR GRADE PLYWOOD 5/8" EXTERIOR GRADE PLYWOOD LEGEND FLOOR I-JOIST, LVL & PSL SHALL BE MANUFACTURED BY TRUS JOIST WEYERHAEUSER OR APPROVED EQUAL. G.C. SHALL BE RESPONSIBLE TO SUBMIT SPECIFICATIONS FOR SUBSTITUTED MANUFACTURER TO ARCHITECT FOR REVIEW PRIOR TO MATERIAL ORDER. L.V.L. LAMINATED VENEER LUMBER 1.9 E (Fb = 2,600 PSI)P.S.L. PARALLEL STRAND LUMBER 2.0 E (Fb = 2,900 PSI)D.F. DIMENSIONAL FRAMING LUMBER NO. 2 DOUGLAS FIR (Fb = 950 PSI) P.T. PRESSURE TREATED LUMBER NO. 1 S.Y.P. (Fb = 1050 PSI) A= 560 SERIES | B= 360 SERIES | C= 230 SERIES FLOOR JOIST SPACING IS 16" ON - CENTER UNLESS OTHERWISE NOTED ON THE FRAMING LAYOUT 5 1/2" LVL FJ-6 \ $2 \times 6$ D.F. 7 1/4" LVL $2 \times 8$ D.F. 9 1/2" TJI FJ-9L \ 9 1/4" or 9 1/2" LVL \* FJ-10 \ $2 \times 10$ D.F. 11 7/8" TJI FJ-IIL 11 1/4" or 11 7/8" LVL \* FJ-12 \ $2 \times 12$ D.F. FJ-14 14" TJI FJ-16 \ \* MATCH DEPTH OF EXISTING JOIST, TRIM NEW JOIST AS REQUIRED. CEILING JOIST SPACING IS 16" ON - CENTER UNLESS OTHERWISE NOTED ON THE FRAMING LAYOUT $2 \times 6$ D.F. 7-LO 7 1/4" LVL 8-LO $2 \times 8$ D.F. 9 1/2" LVL $2 \times 10$ D.F. 11 7/8" LVL CJ-12 $2 \times 12$ D.F. $2 \times 6$ D.F. SLOPED ROOF RAFTER SPACING IS 16" ON-CENTER UNLESS OTHERWISE NOTED ON THE FRAMING LAYOUT **R-6** \ \ 2 x 6 D.F. $2 \times 8$ D.F. R-9 \ 9 1/2" LVL R-10 \(\) 2 x 10 D.F. ARCH 101 11 7/8" LVL R-12 $2 \times 12$ D.F. WESTCHESTER • NEW YORK R-14 14" LVL ROOF PITCH 03/15/16 INTERIOR BEARING WALL REVISIONS: BUILT-UP 2 x POST CONTINUOUS DOWN TO FOUNDATION WALL OR GIRDER 04/25/16 ( MINIMUM POST WIDTH SHALL BE THE BEAM WIDTH PLUS 2 STUDS) QUANTITY OF BUILT-UP STUD POST ARCHITECT'S SEAL DWG No. BUILT-UP POST ABOVE ON BEAM CEILING HEIGHT (ROUGH FRAMING) FRAMING LAYOUT DO NOT SCALE PRINTS

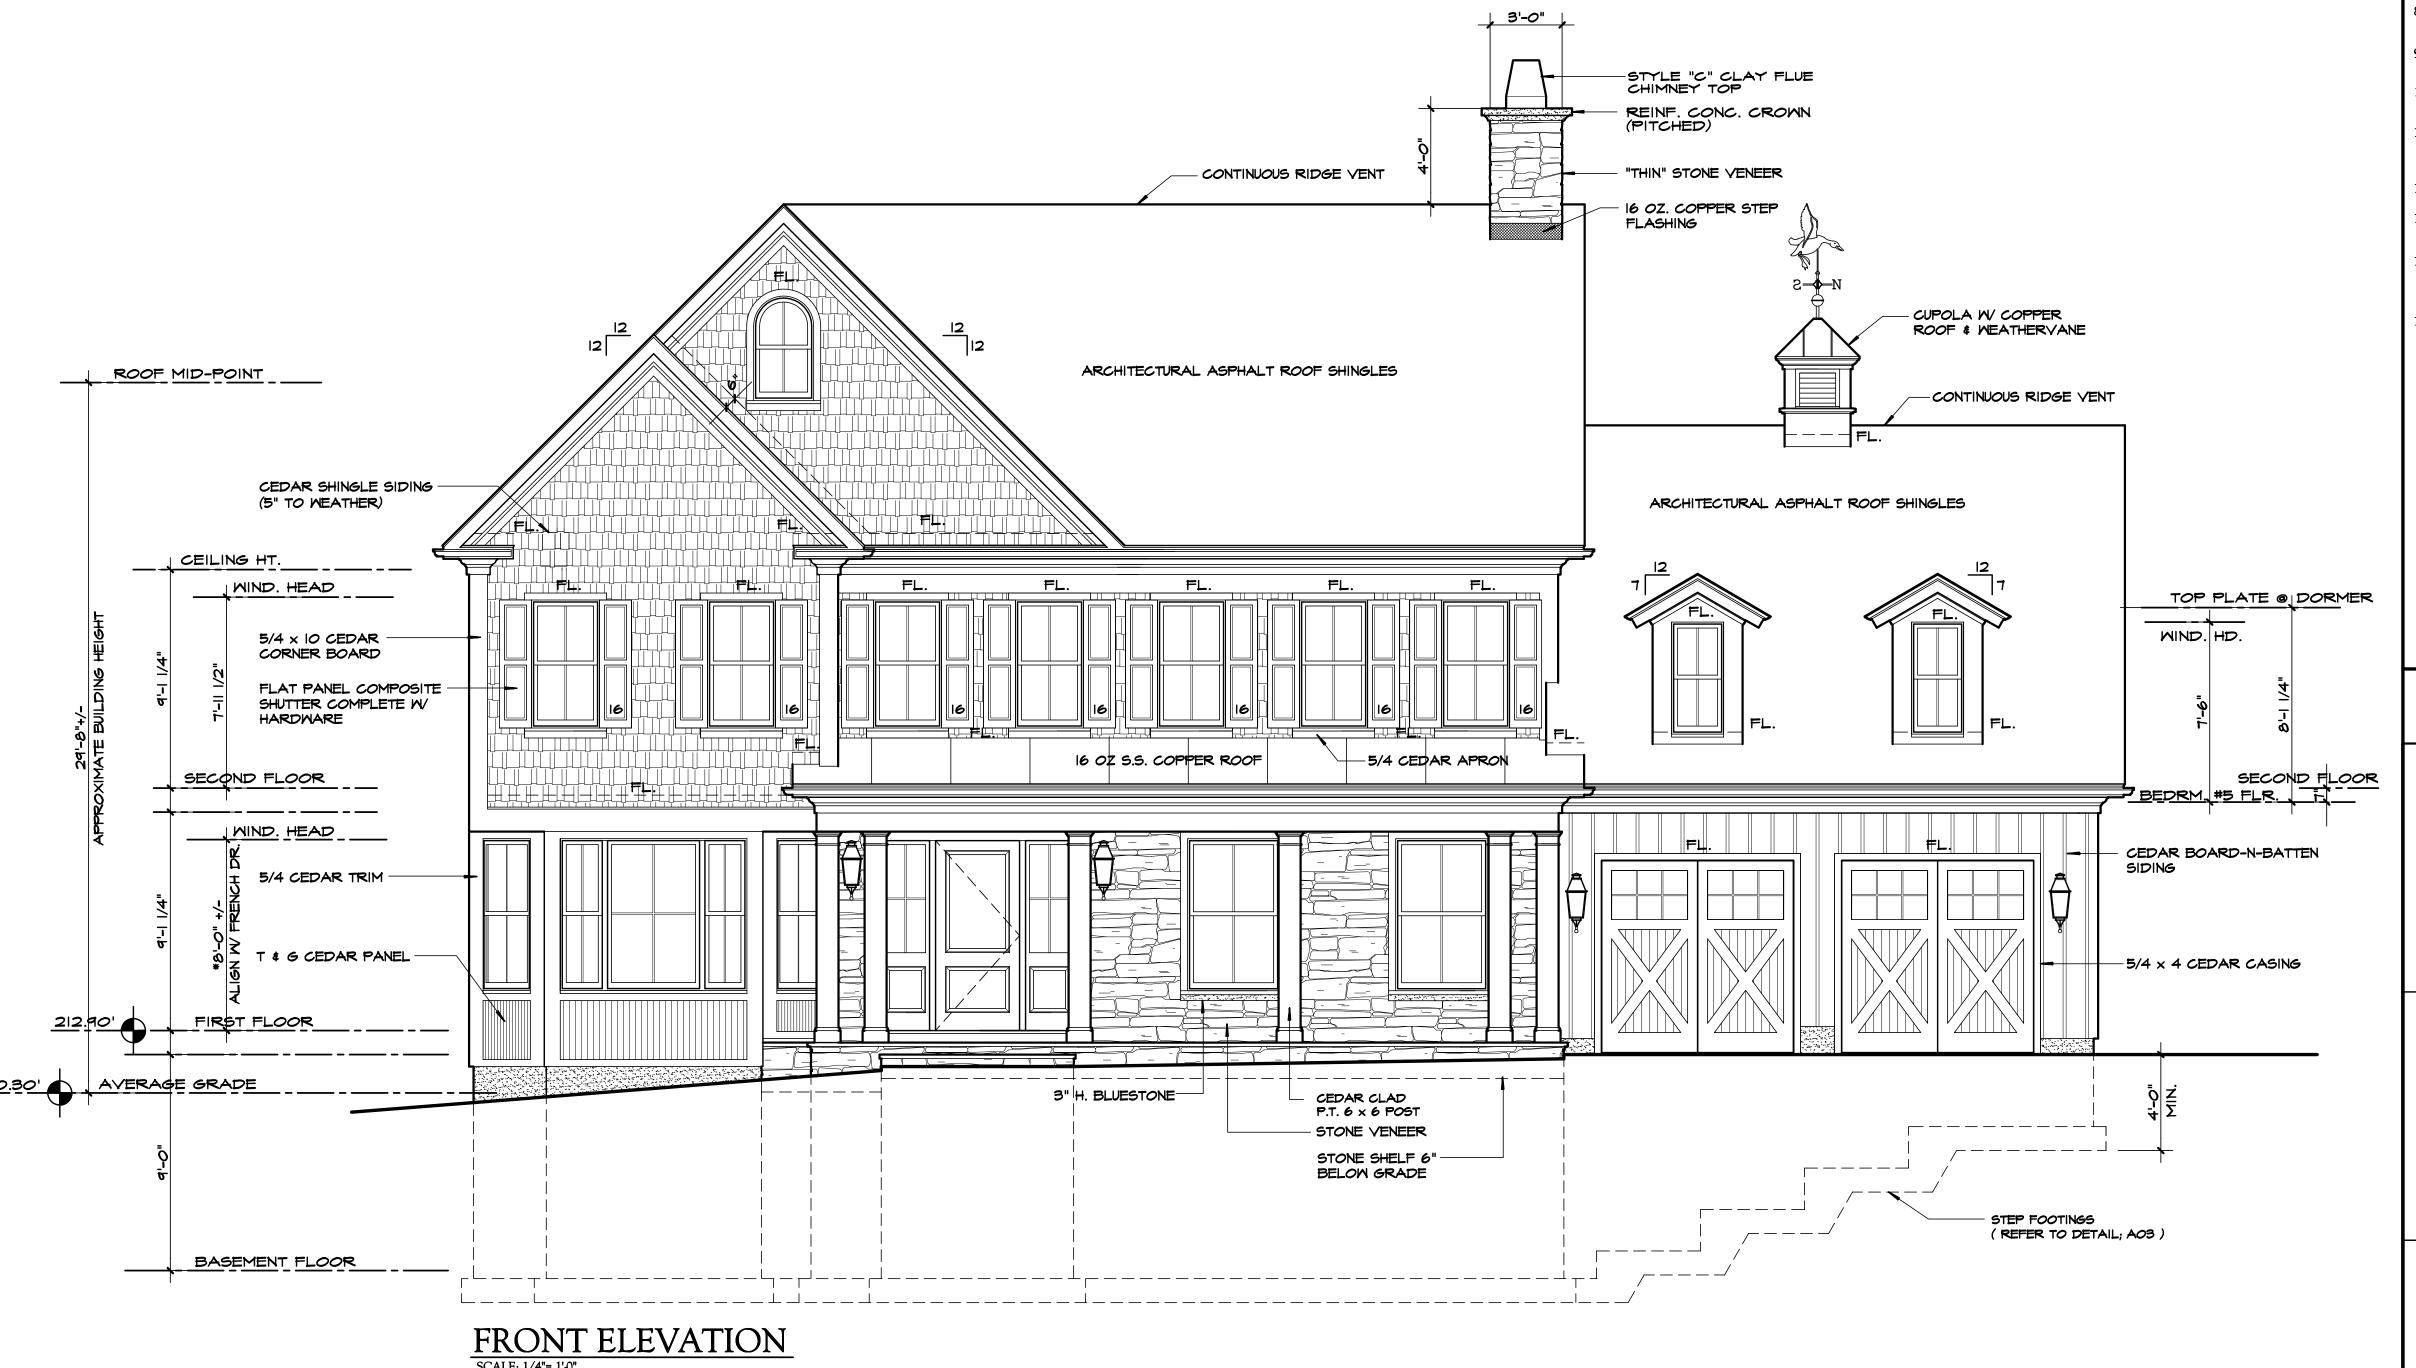

Proposed Residence

- 1. PROVIDE ICE-SHIELD WATERPROOF MEMBRANE BY DUPONT AT ALL EAVES, VALLEYS AND CRICKETS. COVER ENTIRE LOW-PITCH PORCH ROOFS (4/12 & LESS) WITH WATERPROOF MEMBRANE.
- 2. ROOFING SHALL BE "TIMBERLINE ULTRA HD" ASPHALT SHINGLES BY GAF. SUBMIT SAMPLES FOR APPROVAL
- 3. GUTTERS AND LEADERS SHALL BE BAKED ENAMEL ALUMINUM. GUTTER SHALL BE 6"w. K-STYLE.
- 4. ALL FLASHING (CONCEALED AND EXPOSED) SHALL BE 16 oz. COPPER.
- 5. PROVIDE 16 OZ. COPPER SILL PAN FLASHING, AS PER DETAIL, AT ALL EXTERIOR DOOR OPENINGS.
- 6. PROVIDE COPPER DRIP EDGE AT ALL EAVES.
- 7. SIDING SHALL BE PRE-FINSIH WHITE CEDAR SHINGLE. SIDING EXPOSURE SHALL BE 5".
- 8. TRIM SUCH AS FLAT STOCK AND MOULDING SHALL BE CEDAR AND "AZEK" OR EQUAL.
- 9. RIDGE VENTS SHALL BE SHINGLE VENT BY AIRVENT, INC, OR EQUAL.
- 10. PROVIDE "AIR & VAPOR BARRIER" WRAP BY "GRACE" AT ALL WINDOW AND DOOR ROUGH OPENINGS AS PER DETAIL.
- 11. EXTERIOR WALL SHEATHING SHALL BE WRAPPED WITH "HYDROGAP" HOUSEWRAP BY BENJAMIN OBDYKE. ALL SEAMS SHALL BE TAPPED AS PER MANUFACTURER'S SPECIFICATIONS.
- 12. PROVIDE 1 x COMPOSITE KICK BOARD AT EACH DOOR SILL.
- 13. PROVIDE COPPER DRIP CAP FLASHING AT ALL FRIEZES, COLUMN CAPS, WINDOW AND DOOR HEAD TRIM.
- 14. PROVIDE CEDAR J-BLOCKS AT EXTERIOR WALLS FOR MOUNTING OF LANTERNS, HOSE BIBS, ELECTRICAL OUTLETS, ETC. AS PER DETAIL.
- 15. G.C. SHALL DEVELOP PAINTING AND/OR STAINING SCHEDULE AND SPECIFICATIONS WITH OWNER. SUBMIT PROPOSAL AND SAMPLES AS REQUESTED.

## 23 Shawnee

Road, LLC

23 Shawnee Road

Scarsdale N.Y.

# FINISH SCHEDULE

NAME COLOR	GAF TIMBERLINE CHARCOAL	MAIBEC CEDAR SHINGLE WHITE	CEDAR FLAT STOCK & WHITE MOULDING PROFILES	ANDERSEN 400 SERIES WHITE	COMPOSITE FLAT PANEL BLACK	CUSTOM CEDAR / "AZEK" WHITE	CUSTOM MAHOGANY BLACK	CUSTOM CARRIAGE STYLE WHITE	FIELDSTONE NATURAL STONE GRAY/BROWN	"TIMBER TECH" COMPOSITE GRAY
BUILDING COMPONENT	ROOFING	SIDING	TRIM	WINDOW	SHUTTER	COLUMN	ENTRANCE DOOR	GARAGE DOOR	MASONRY VENEER	WOOD DECK

DO NOT SCALE PRINTS

ARCH 101
WESTCHESTER • NEW YORK

DATE: 03/15/16

REVISIONS: 04/25/16


ARCHITECT'S SEAL

DWG No.

A13

ELEVATION

23 shawnee rd/216002

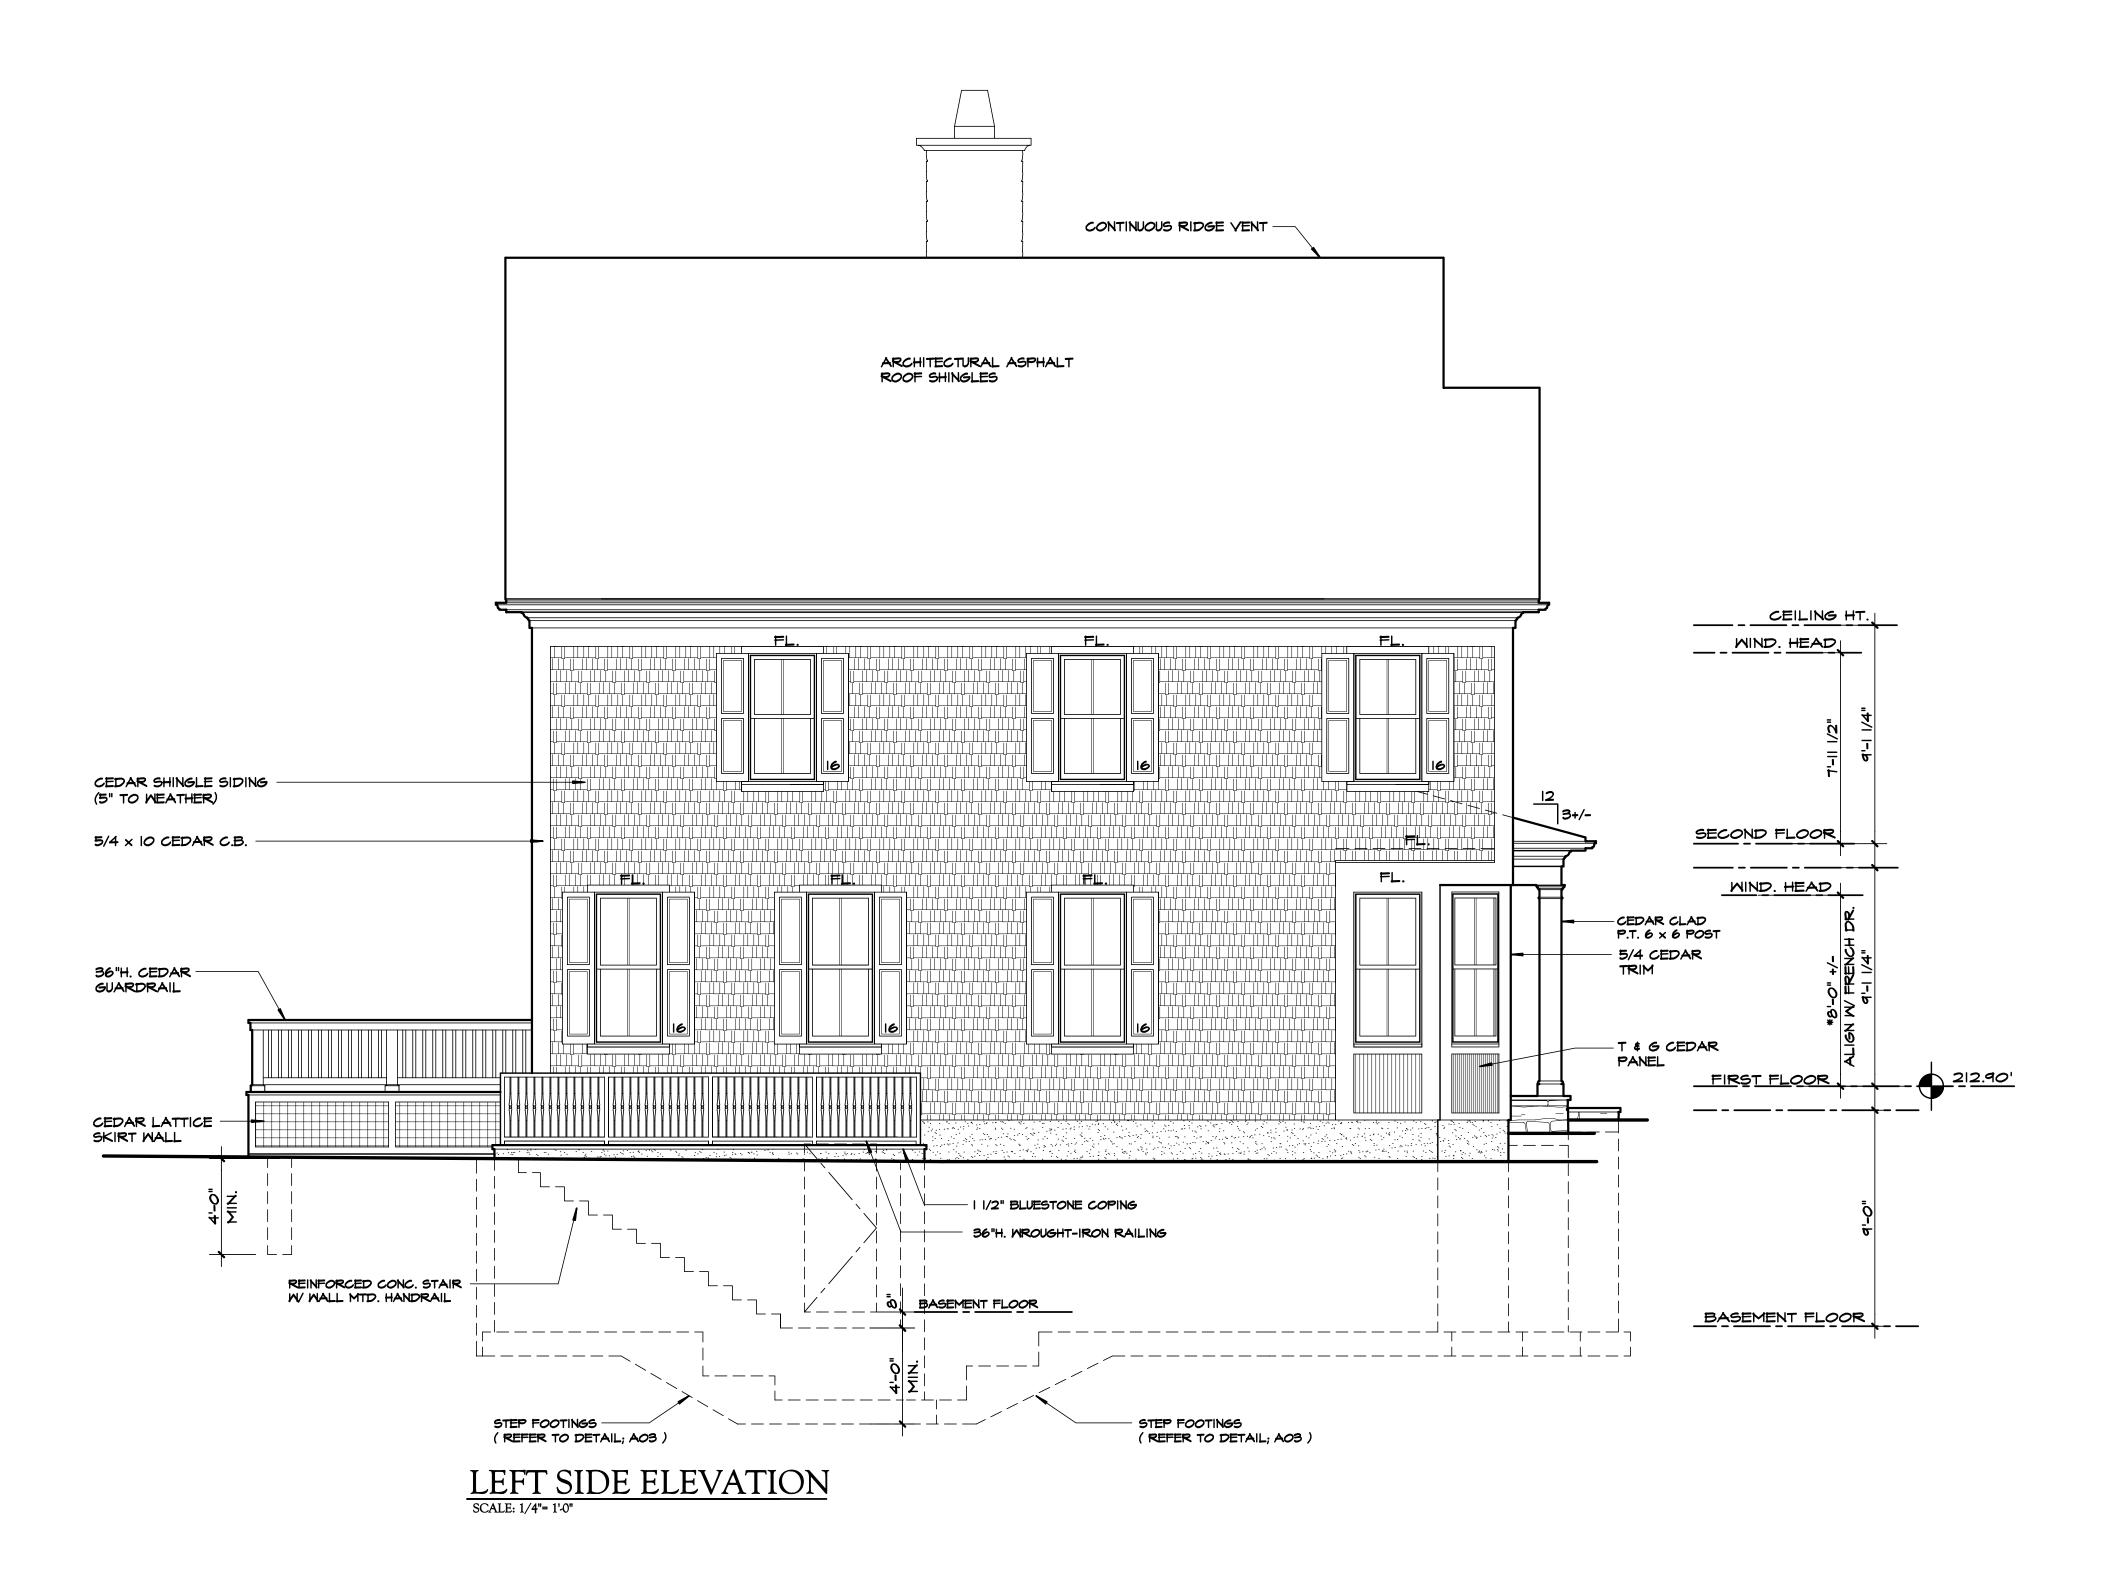

Proposed Residence

- 1. PROVIDE ICE-SHIELD WATERPROOF MEMBRANE BY DUPONT AT ALL EAVES, VALLEYS AND CRICKETS. COVER ENTIRE LOW-PITCH PORCH ROOFS (4/12 & LESS) WITH WATERPROOF MEMBRANE.
- 2. ROOFING SHALL BE "TIMBERLINE ULTRA HD" ASPHALT SHINGLES BY GAF. SUBMIT SAMPLES FOR APPROVAL
- 3. GUTTERS AND LEADERS SHALL BE BAKED ENAMEL ALUMINUM. GUTTER SHALL BE 6"w. K-STYLE.
- 4. ALL FLASHING (CONCEALED AND EXPOSED) SHALL BE 16 oz. COPPER.
- 5. PROVIDE 16 OZ. COPPER SILL PAN FLASHING, AS PER DETAIL, AT ALL EXTERIOR DOOR OPENINGS.
- 6. PROVIDE COPPER DRIP EDGE AT ALL EAVES.
- 7. SIDING SHALL BE PRE-FINSIH WHITE CEDAR SHINGLE. SIDING EXPOSURE SHALL BE 5".
- 8. TRIM SUCH AS FLAT STOCK AND MOULDING SHALL BE CEDAR AND "AZEK" OR EQUAL.
- 9. RIDGE VENTS SHALL BE SHINGLE VENT BY AIRVENT, INC, OR EQUAL.
- 10. PROVIDE "AIR & VAPOR BARRIER" WRAP BY "GRACE" AT ALL WINDOW AND DOOR ROUGH OPENINGS AS PER DETAIL.
- 11. EXTERIOR WALL SHEATHING SHALL BE WRAPPED WITH "HYDROGAP" HOUSEWRAP BY BENJAMIN OBDYKE. ALL SEAMS SHALL BE TAPPED AS PER MANUFACTURER'S SPECIFICATIONS.
- 12. PROVIDE 1 x COMPOSITE KICK BOARD AT EACH DOOR SILL.
- 13. PROVIDE COPPER DRIP CAP FLASHING AT ALL FRIEZES, COLUMN CAPS, WINDOW AND DOOR HEAD TRIM.
- 14. PROVIDE CEDAR J-BLOCKS AT EXTERIOR WALLS FOR MOUNTING OF LANTERNS, HOSE BIBS, ELECTRICAL OUTLETS, ETC. AS PER DETAIL.
- 15. G.C. SHALL DEVELOP PAINTING AND/OR STAINING SCHEDULE AND SPECIFICATIONS WITH OWNER. SUBMIT PROPOSAL AND SAMPLES AS REQUESTED.

## 23 Shawnee

Road, LLC

23 Shawnee Road

Scarsdale N.Y.

# FINISH SCHEDULE

BUILDING COMPONENT	NAME	TYPE	COLOR
ROOFING	GAF	TIMBERLINE	CHARCOAL
SIDING	MAIBEC	CEDAR SHINGLE	WHITE
TRIM	CEDAR	FLAT STOCK & MOULDING PROFILES	WHITE
WINDOW	ANDERSEN	400 SERIES	WHITE
SHUTTER	COMPOSITE	FLAT PANEL	BLACK
COLUMN	CUSTOM	CEDAR / "AZEK"	WHITE
ENTRANCE DOOR	CUSTOM	MAHOGANY	BLACK
GARAGE DOOR	CUSTOM	CARRIAGE STYLE	WHITE
MASONRY VENEER	FIELDSTONE	NATURAL STONE	GRAY/BROWN
WOOD DECK	"TIMBER TECH"	COMPOSITE	GRAY
D.			

DO NOT SCALE PRINTS

ARCH 101

WESTCHESTER • NEW YORK

DATE:

03/15/16

REVISIONS:


04/25/16

ARCHITECTS SEAL

DWG No.

A14

ELEVATION

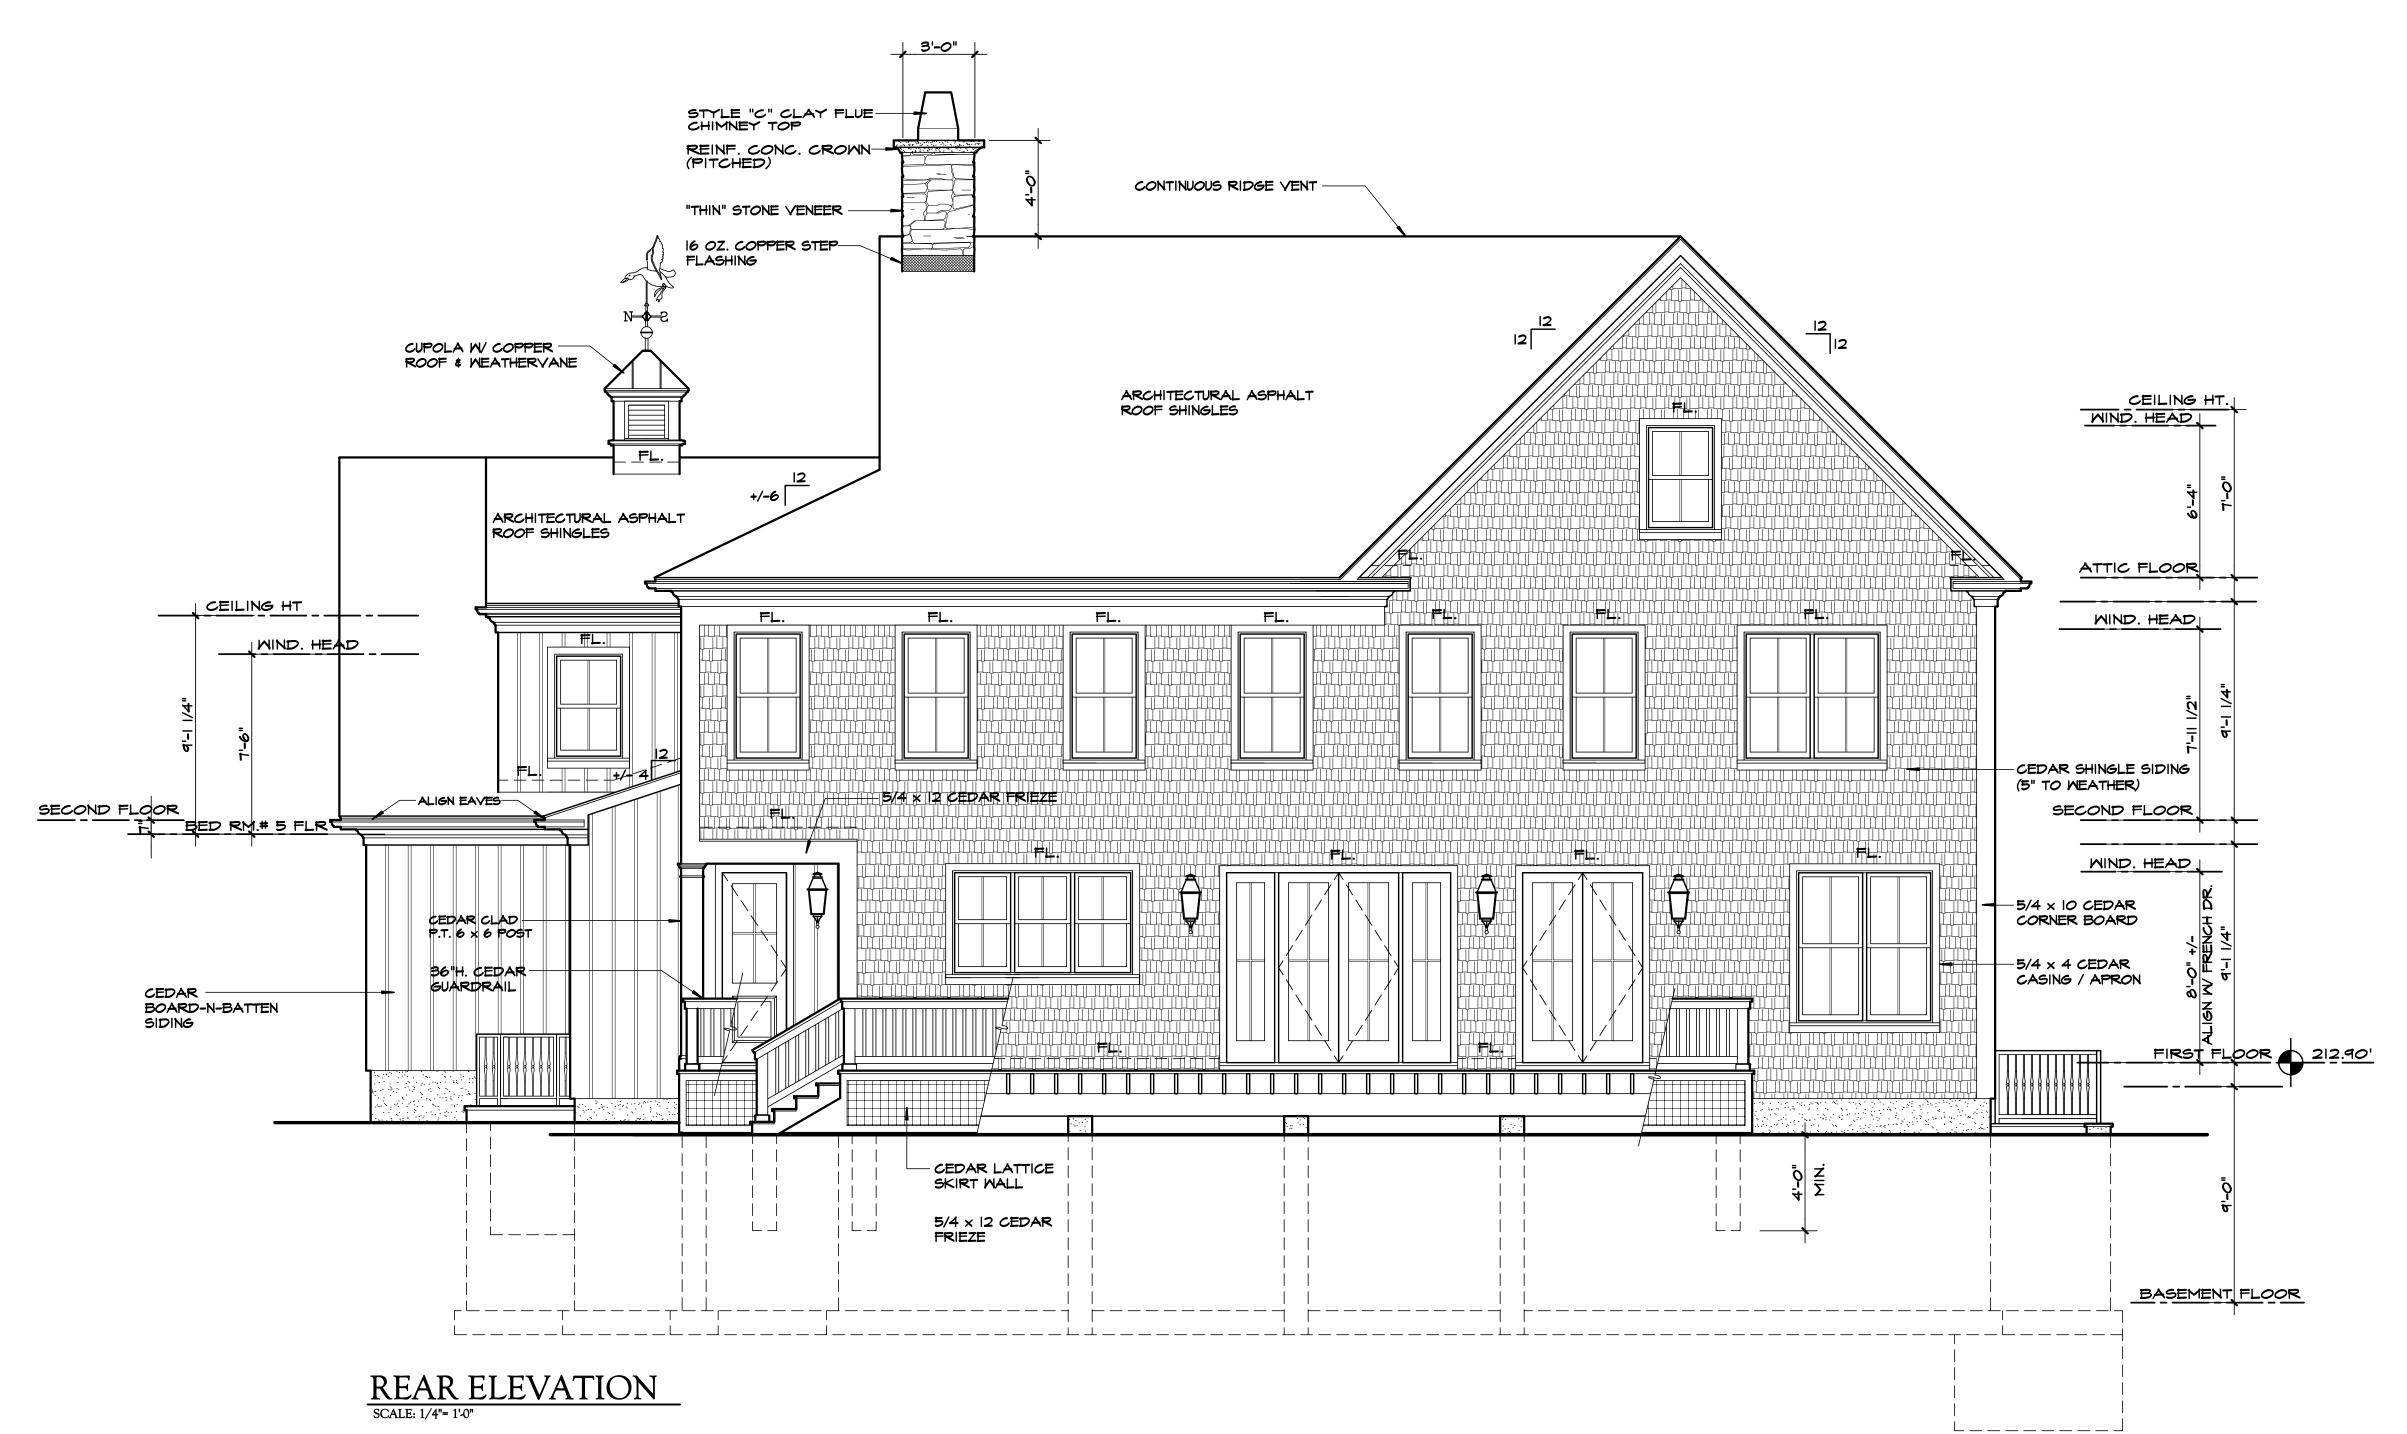

Proposed Residence

- 1. PROVIDE ICE-SHIELD WATERPROOF MEMBRANE BY DUPONT AT ALL EAVES, VALLEYS AND CRICKETS. COVER ENTIRE LOW-PITCH PORCH ROOFS (4/12 & LESS) WITH WATERPROOF MEMBRANE.
- 2. ROOFING SHALL BE "TIMBERLINE ULTRA HD" ASPHALT SHINGLES BY GAF. SUBMIT SAMPLES FOR APPROVAL
- 3. GUTTERS AND LEADERS SHALL BE BAKED ENAMEL ALUMINUM. GUTTER SHALL BE 6"w. K-STYLE.
- 4. ALL FLASHING (CONCEALED AND EXPOSED) SHALL BE 16 oz. COPPER.
- 5. PROVIDE 16 OZ. COPPER SILL PAN FLASHING, AS PER DETAIL, AT ALL EXTERIOR DOOR OPENINGS.
- 6. PROVIDE COPPER DRIP EDGE AT ALL EAVES.
- 7. SIDING SHALL BE PRE-FINSIH WHITE CEDAR SHINGLE. SIDING EXPOSURE SHALL BE 5".
- 8. TRIM SUCH AS FLAT STOCK AND MOULDING SHALL BE CEDAR AND "AZEK" OR EQUAL.
- 9. RIDGE VENTS SHALL BE SHINGLE VENT BY AIRVENT, INC, OR EQUAL.
- 10. PROVIDE "AIR & VAPOR BARRIER" WRAP BY "GRACE" AT ALL WINDOW AND DOOR ROUGH OPENINGS AS PER DETAIL.
- 11. EXTERIOR WALL SHEATHING SHALL BE WRAPPED WITH
- "HYDROGAP" HOUSEWRAP BY BENJAMIN OBDYKE. ALL SEAMS SHALL BE TAPPED AS PER MANUFACTURER'S SPECIFICATIONS.
- 12. PROVIDE 1 x COMPOSITE KICK BOARD AT EACH DOOR SILL.
- 13. PROVIDE COPPER DRIP CAP FLASHING AT ALL FRIEZES, COLUMN CAPS, WINDOW AND DOOR HEAD TRIM.
- 14. PROVIDE CEDAR J-BLOCKS AT EXTERIOR WALLS FOR MOUNTING OF LANTERNS, HOSE BIBS, ELECTRICAL OUTLETS, ETC. AS PER DETAIL.
- 15. G.C. SHALL DEVELOP PAINTING AND/OR STAINING SCHEDULE AND SPECIFICATIONS WITH OWNER. SUBMIT PROPOSAL AND SAMPLES AS REQUESTED.

# 23 Shawnee

Road, LLC

23 Shawnee Road

Scarsdale N.Y.

# FINISH SCHEDULE

COLOR	CHARCOAL	WHITE	FILES WHITE	WHITE	BLACK	WHITE	BLACK	WHITE	GRAY/BROWN	GRAY
TYPE	TIMBERLINE	CEDAR SHINGLE	FLAT STOCK & MOULDING PROFILES	400 SERIES	FLAT PANEL	CEDAR / "AZEK"	MAHOGANY	CARRIAGE STYLE	NATURAL STONE	COMPOSITE
NAME	GAF	MAIBEC	CEDAR	ANDERSEN	COMPOSITE	CUSTOM	CUSTOM	CUSTOM	FIELDSTONE	"TIMBER TECH"
BUILDING COMPONENT	ROOFING	SIDING	TRIM	WINDOW	SHUTTER	COLUMN	ENTRANCE DOOR	GARAGE DOOR	MASONRY VENEER	WOOD DECK
	D	O N	107	ΓSO	CAI	LE I	PRI	NT	S	


ARCH 101
WESTCHESTER • NEW YORK

DATE: 03/15/16

REVISIONS: 04/25/16

ARCHITECTS SEAL DWG No. A 15

ELEVATION 23 shawnee rd/216002

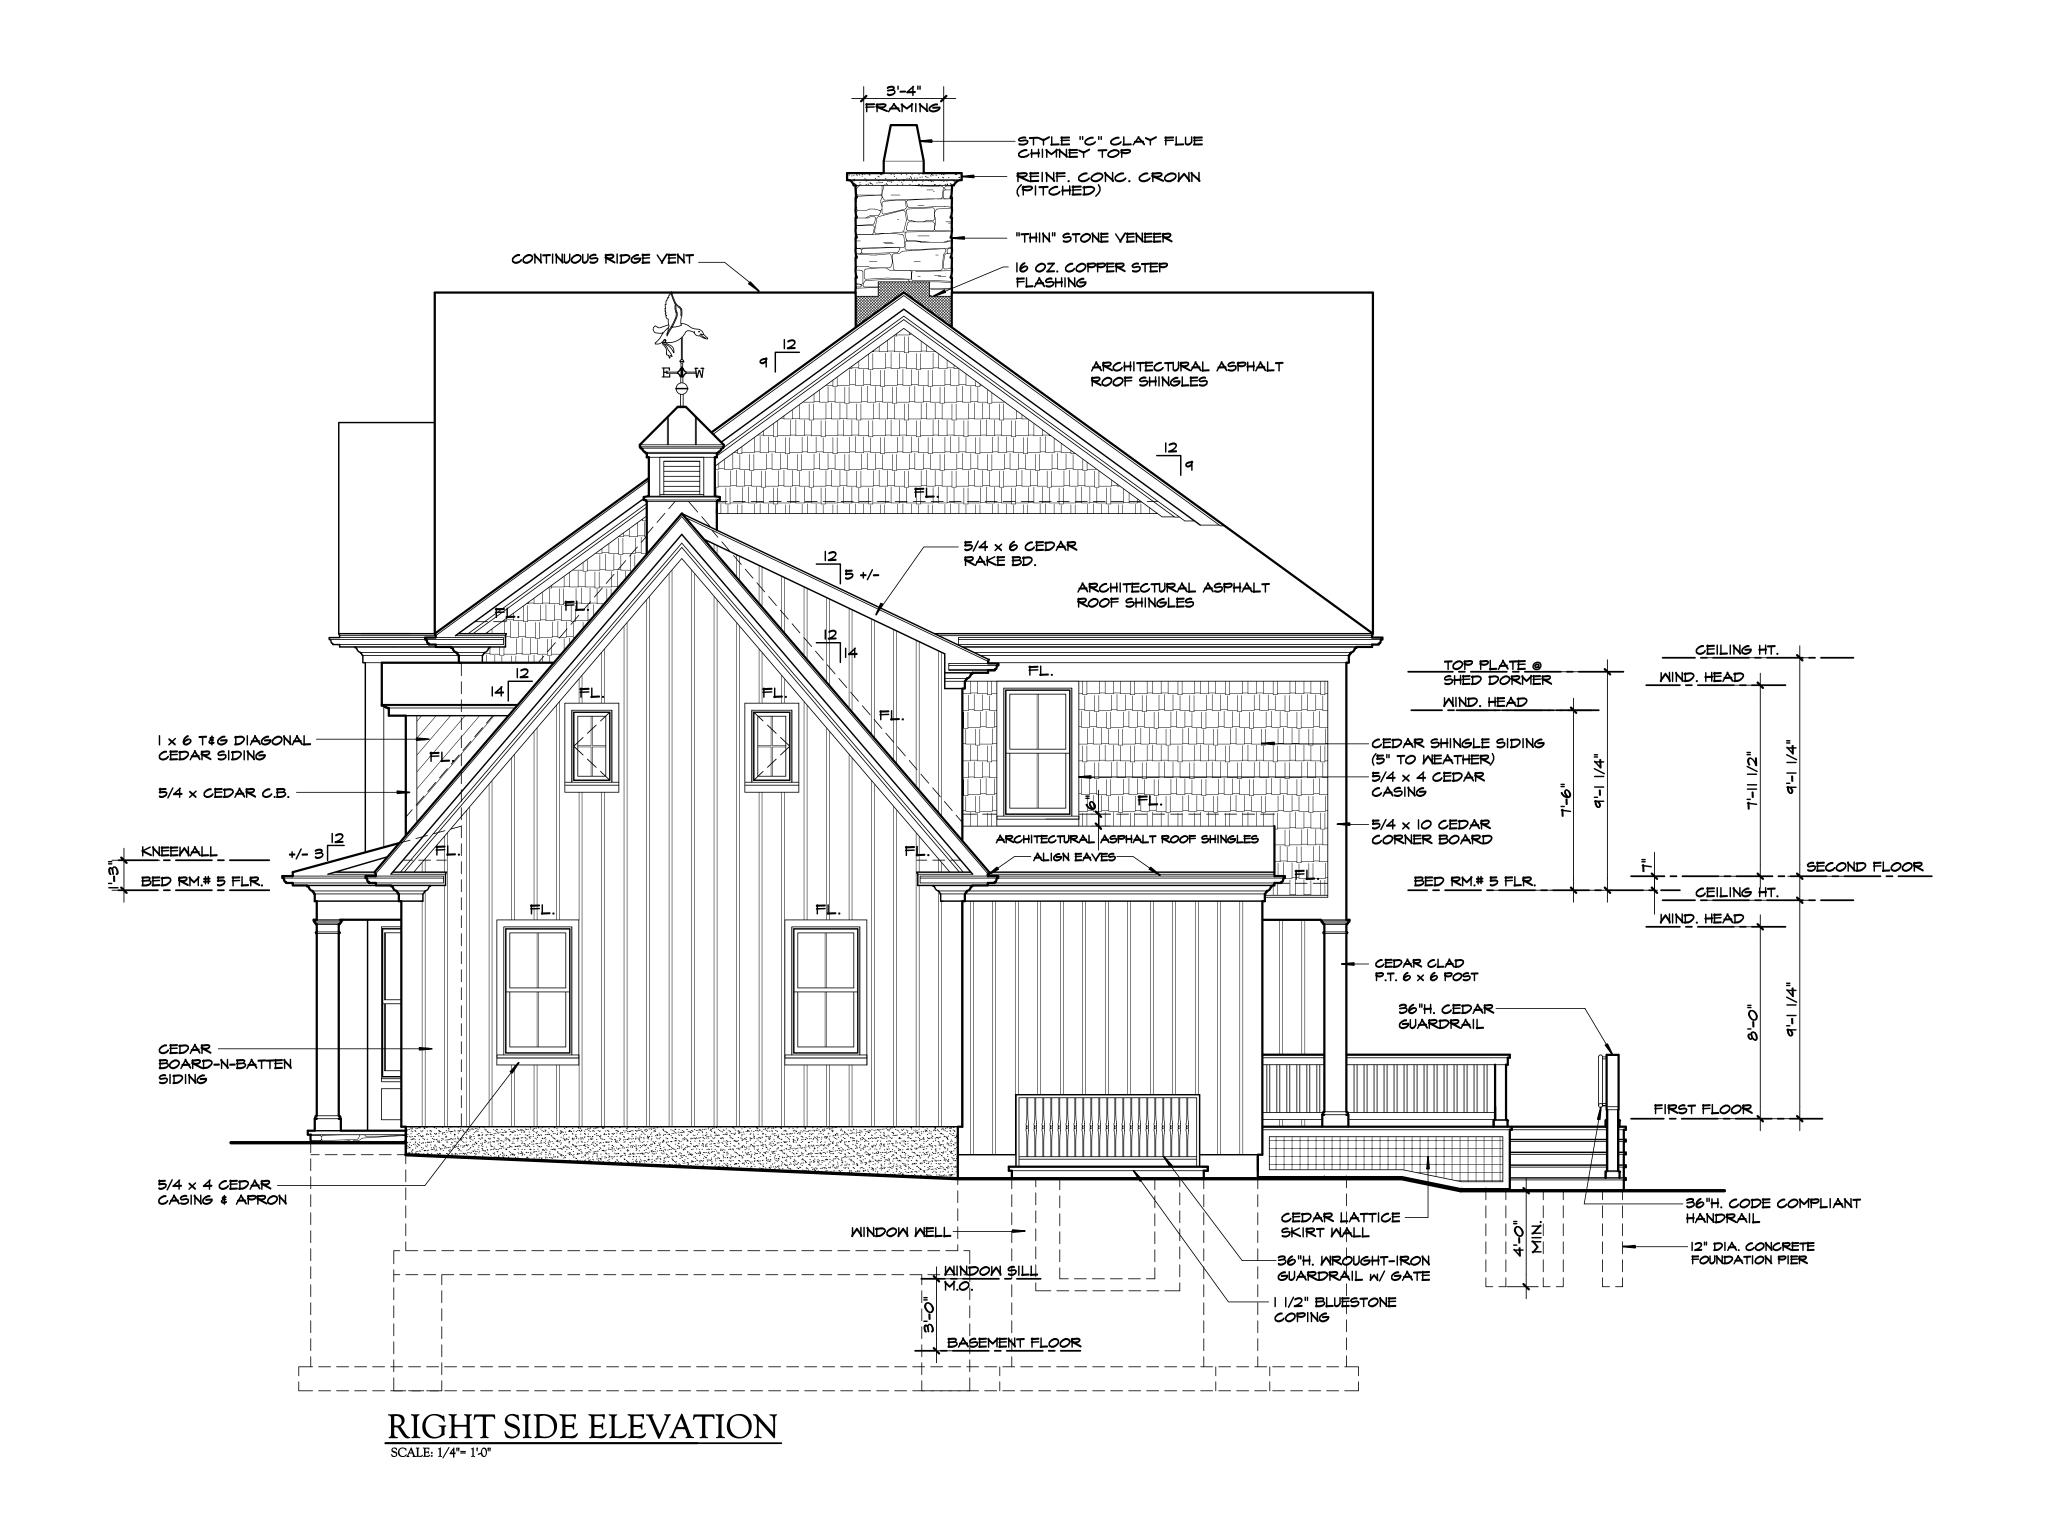

Proposed Residence

- 1. PROVIDE ICE-SHIELD WATERPROOF MEMBRANE BY DUPONT AT ALL EAVES, VALLEYS AND CRICKETS. COVER ENTIRE LOW-PITCH PORCH ROOFS (4/12 & LESS) WITH WATERPROOF MEMBRANE.
- 2. ROOFING SHALL BE "TIMBERLINE ULTRA HD" ASPHALT SHINGLES BY GAF. SUBMIT SAMPLES FOR APPROVAL
- 3. GUTTERS AND LEADERS SHALL BE BAKED ENAMEL ALUMINUM. GUTTER SHALL BE 6"w. K-STYLE.
- 4. ALL FLASHING (CONCEALED AND EXPOSED) SHALL BE 16 oz. COPPER.
- 5. PROVIDE 16 OZ. COPPER SILL PAN FLASHING, AS PER DETAIL, AT ALL EXTERIOR DOOR OPENINGS.
- 6. PROVIDE COPPER DRIP EDGE AT ALL EAVES.
- 7. SIDING SHALL BE PRE-FINSIH WHITE CEDAR SHINGLE. SIDING EXPOSURE SHALL BE 5".
- 8. TRIM SUCH AS FLAT STOCK AND MOULDING SHALL BE CEDAR AND "AZEK" OR EQUAL.
- 9. RIDGE VENTS SHALL BE SHINGLE VENT BY AIRVENT, INC, OR EQUAL.
- 10. PROVIDE "AIR & VAPOR BARRIER" WRAP BY "GRACE" AT ALL WINDOW AND DOOR ROUGH OPENINGS AS PER DETAIL.
- 11. EXTERIOR WALL SHEATHING SHALL BE WRAPPED WITH "HYDROGAP" HOUSEWRAP BY BENJAMIN OBDYKE. ALL SEAMS SHALL BE TAPPED AS PER MANUFACTURER'S SPECIFICATIONS.
- 12. PROVIDE 1 x COMPOSITE KICK BOARD AT EACH DOOR SILL.
- 13. PROVIDE COPPER DRIP CAP FLASHING AT ALL FRIEZES, COLUMN CAPS, WINDOW AND DOOR HEAD TRIM.
- 14. PROVIDE CEDAR J-BLOCKS AT EXTERIOR WALLS FOR MOUNTING OF LANTERNS, HOSE BIBS, ELECTRICAL OUTLETS, ETC. AS PER DETAIL.
- 15. G.C. SHALL DEVELOP PAINTING AND/OR STAINING SCHEDULE AND SPECIFICATIONS WITH OWNER. SUBMIT PROPOSAL AND SAMPLES AS REQUESTED.

# 23 Shawnee

Road, LLC

23 Shawnee Road

Scarsdale N.Y.


# FINISH SCHEDULE


BUILDIN	G ROOFING		OL TRIM	MOGNIM S	SHUTTER	COLUMN	ENTRAN	GARAGE DOOR		WOOD DECK	
BUILDING COMPONENT	'n			Λ	γ.	7	ENTRANCE DOOR	DOOR	MASONRY VENEER	ECK	I
NAME	GAF	MAIBEC	CEDAR	ANDERSEN	COMPOSITE	CUSTOM	CUSTOM	CUSTOM	FIELDSTONE	"TIMBER TECH"	
TYPE	TIMBERLINE	CEDAR SHINGLE	FLAT STOCK & MOULDING PROFILES	400 SERIES	FLAT PANEL	CEDAR / "AZEK"	MAHOGANY	CARRIAGE STYLE	NATURAL STONE	COMPOSITE	
COLOR	CHARCOAL	WHITE	WHITE	WHITE	BLACK	WHITE	BLACK	WHITE	GRAY/BROWN	GRAY	

ARCH 101

WESTCHESTER • NEW YORK

ГЕ:	03/15/16	
/ISION	IS:	
	04/25/16	
		ARCHITECT'S SEAL
		DWG No.
		L A 16
		ELEVATION
		23 shawnee rd/216002

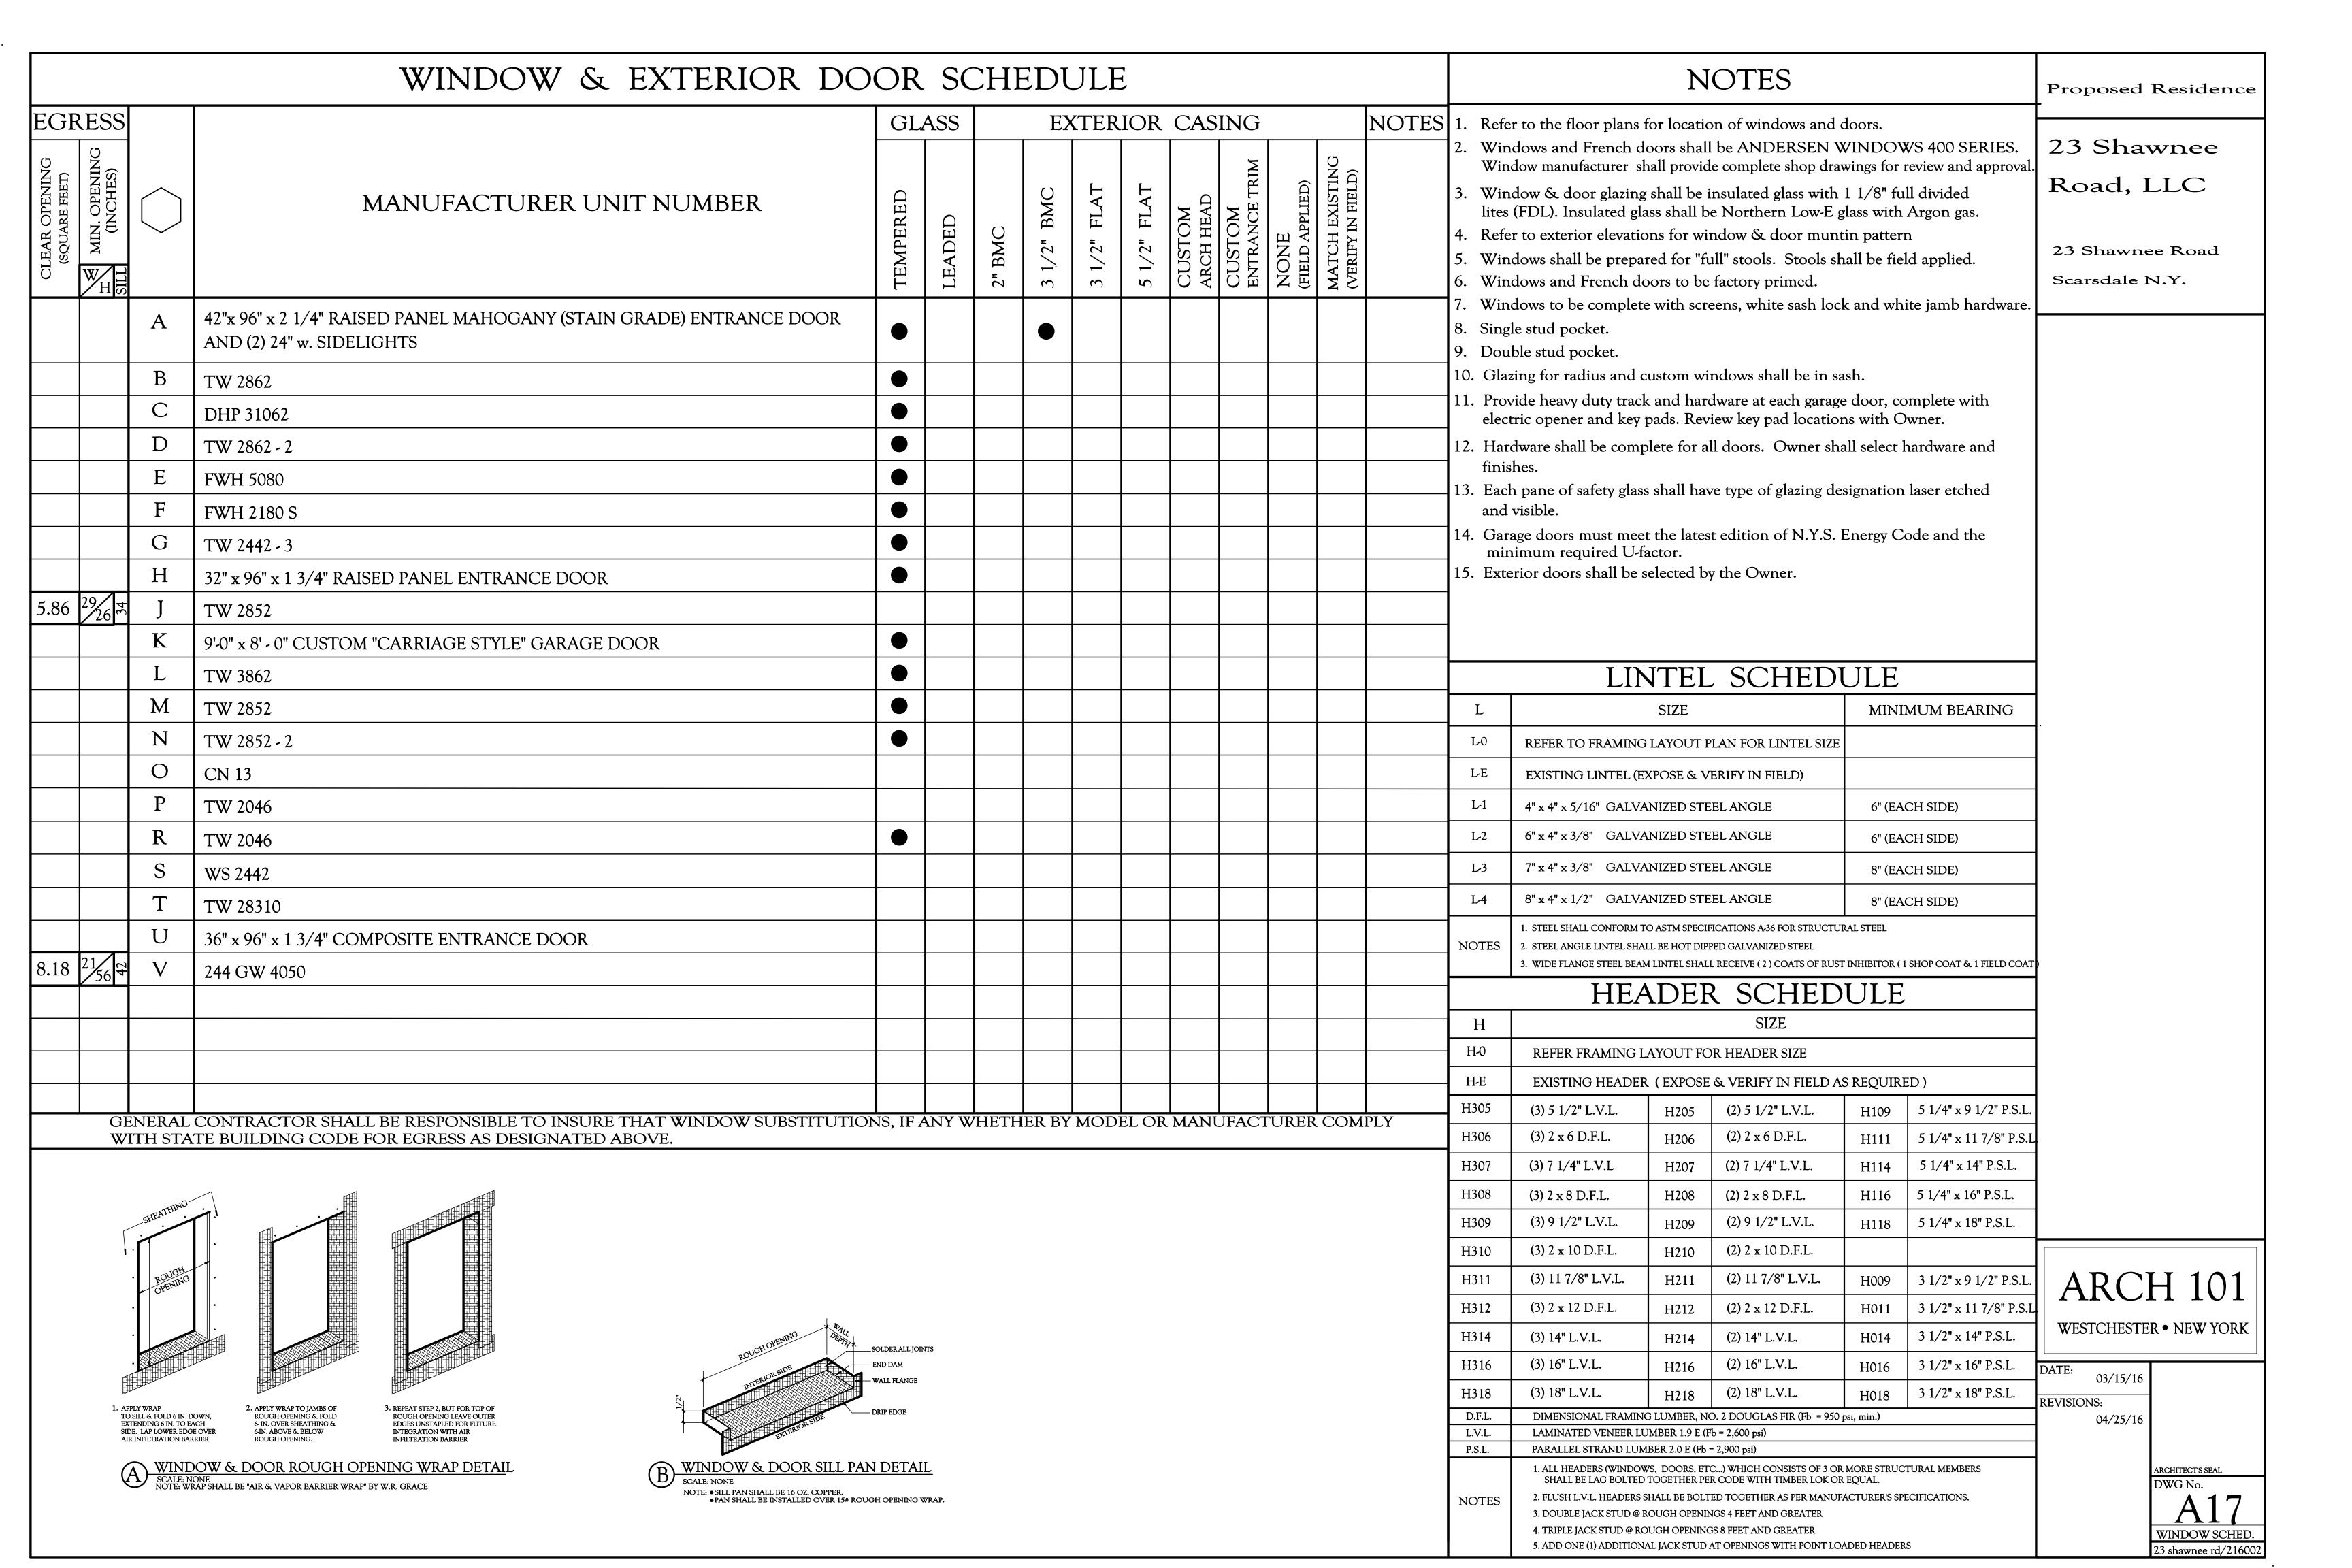

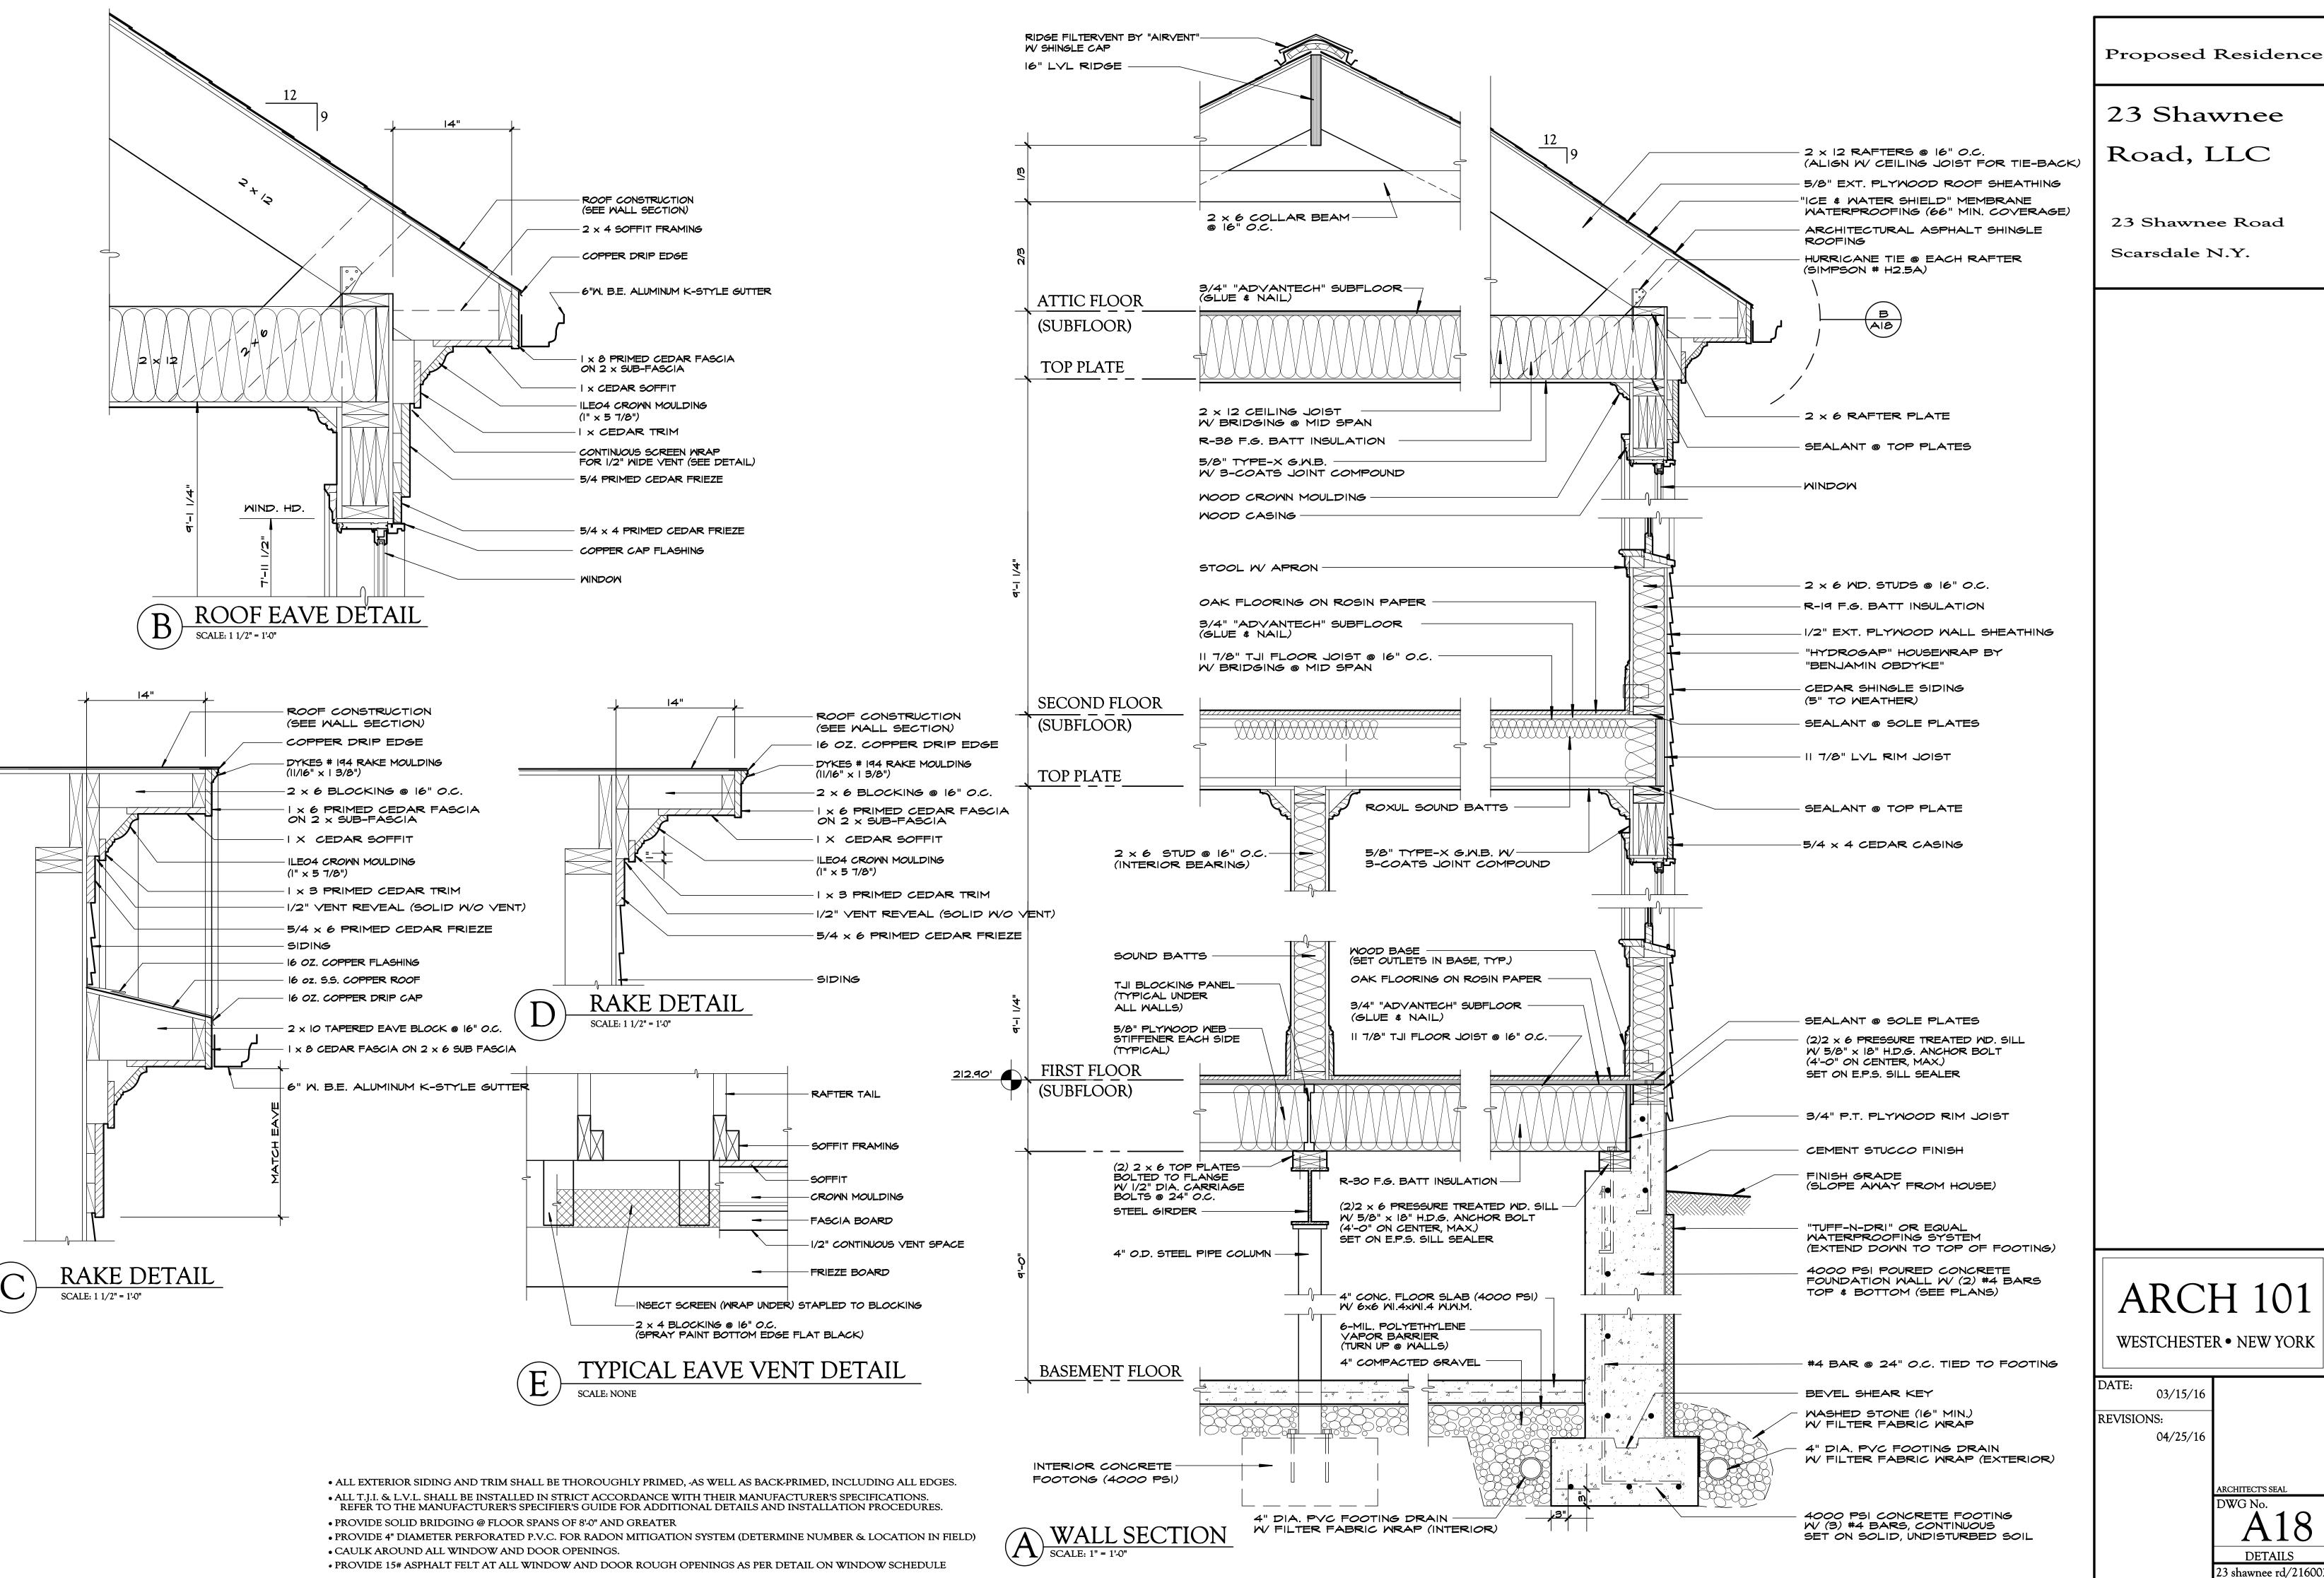

Proposed Residence

ARCH 101


Proposed Residence

Road, LLC


23 Shawnee Road Scarsdale N.Y.

ARCH 101

ARCHITECT'S SEAL A19 23 shawnee rd/216002

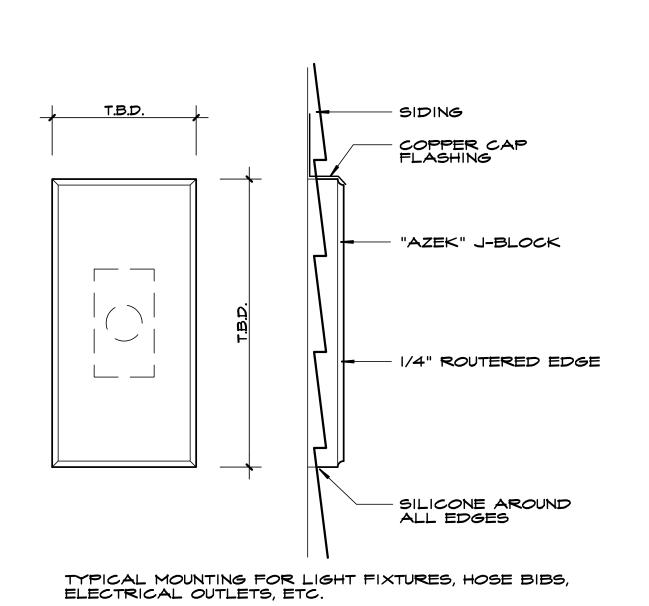





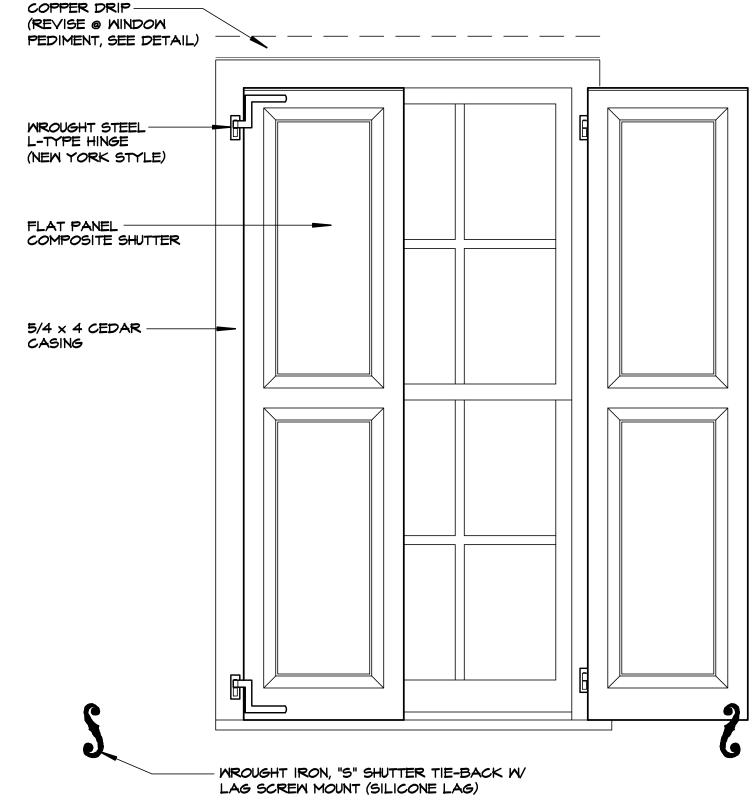


B SHUTTER DETAIL


SCALE: 1" = 1'-0"

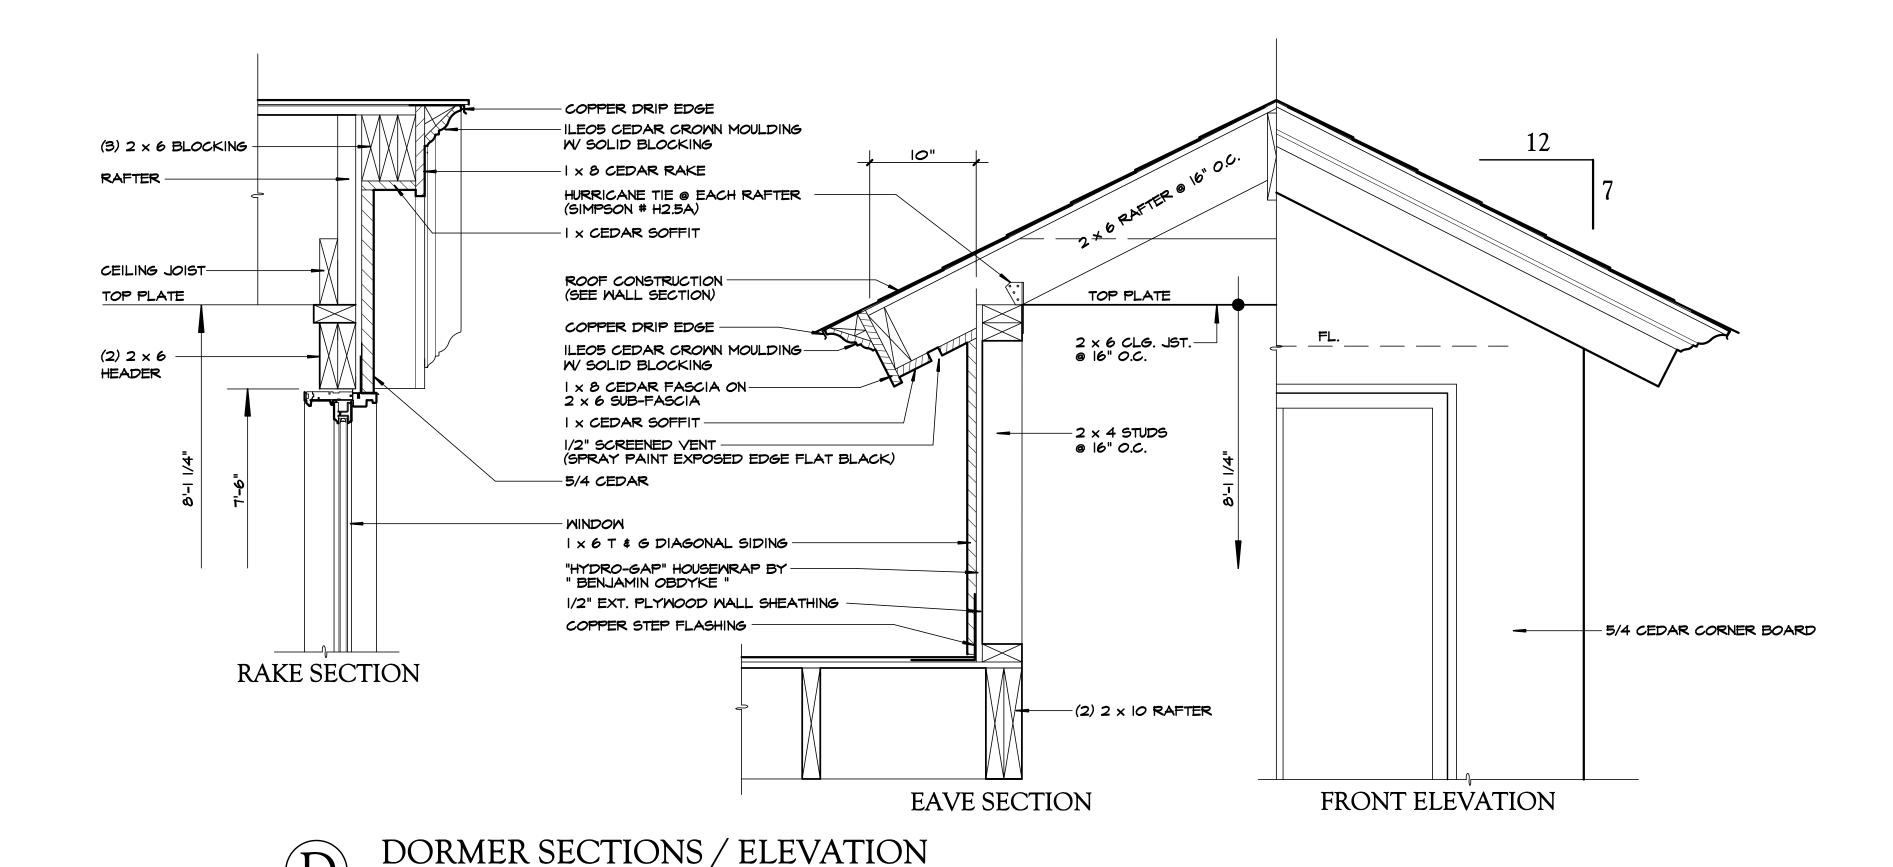

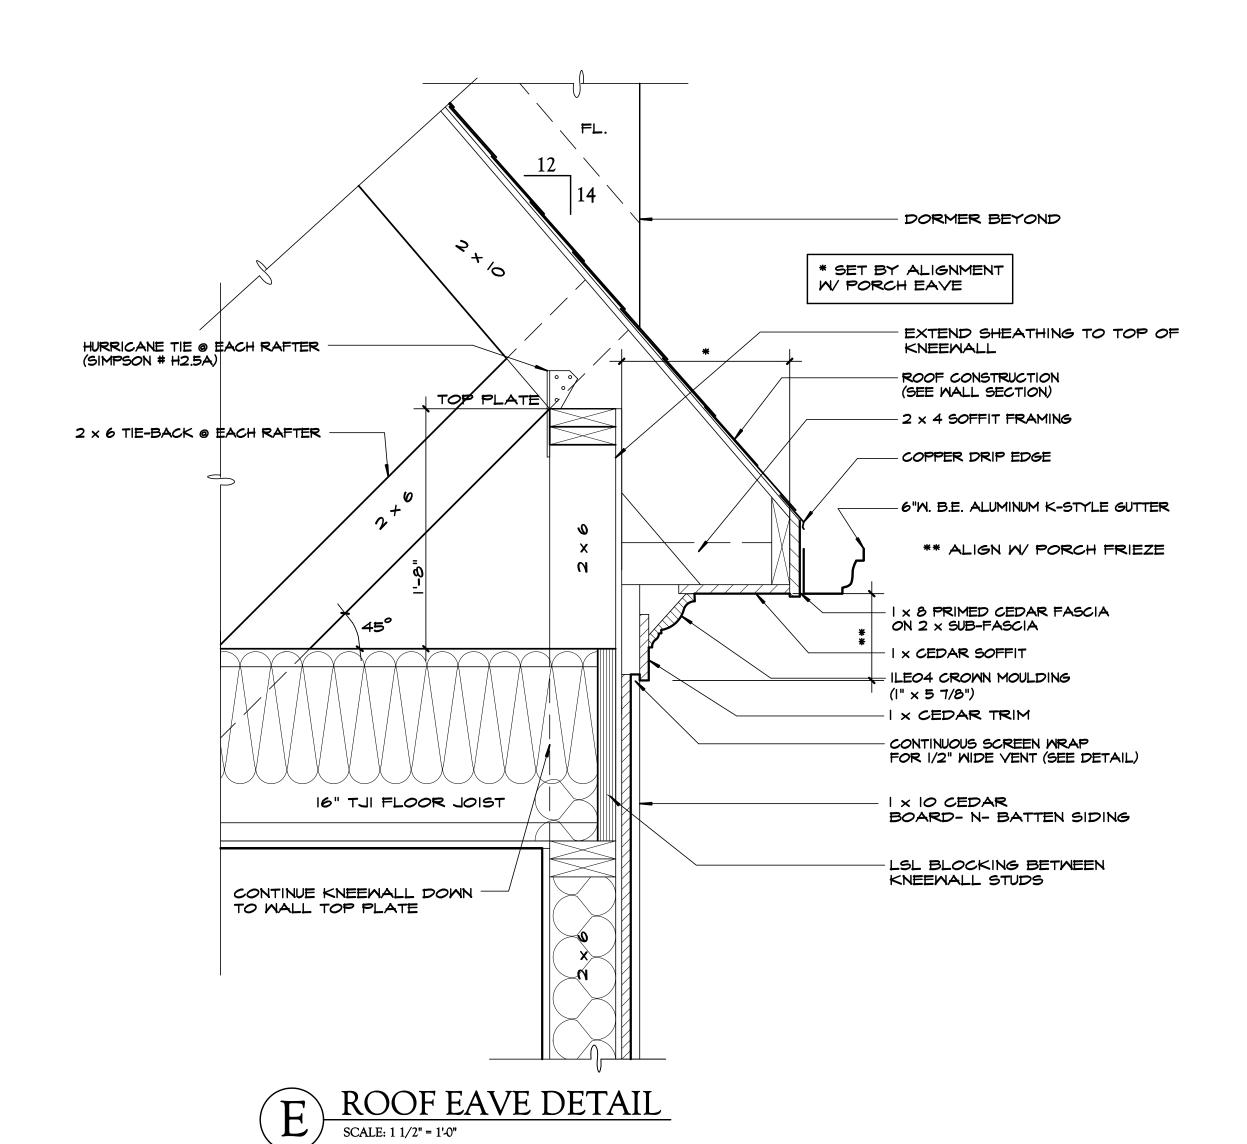


SCALE: 1 1/2" = 1'-0"

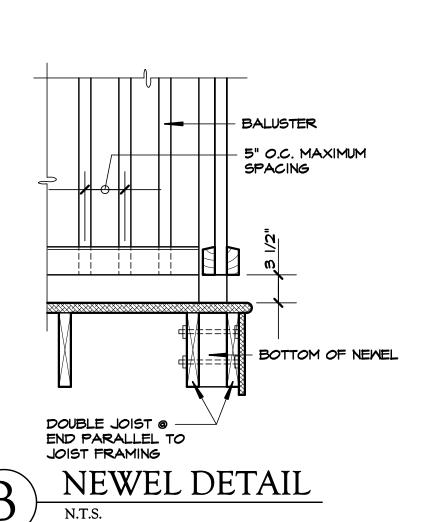

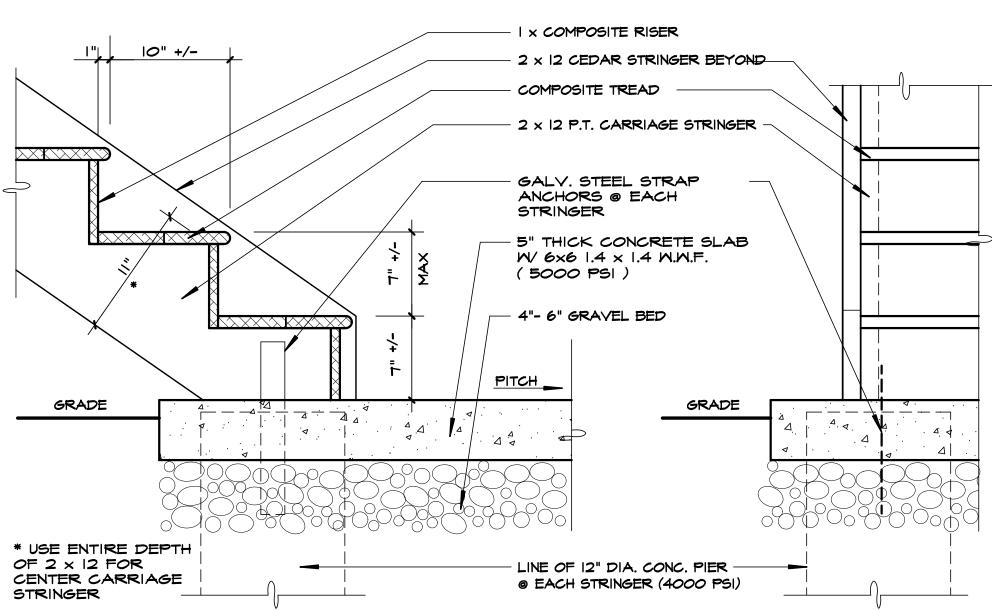

EXTERIOR STAIR DETAIL

SCALE: 1 1/2" = 1'-0"

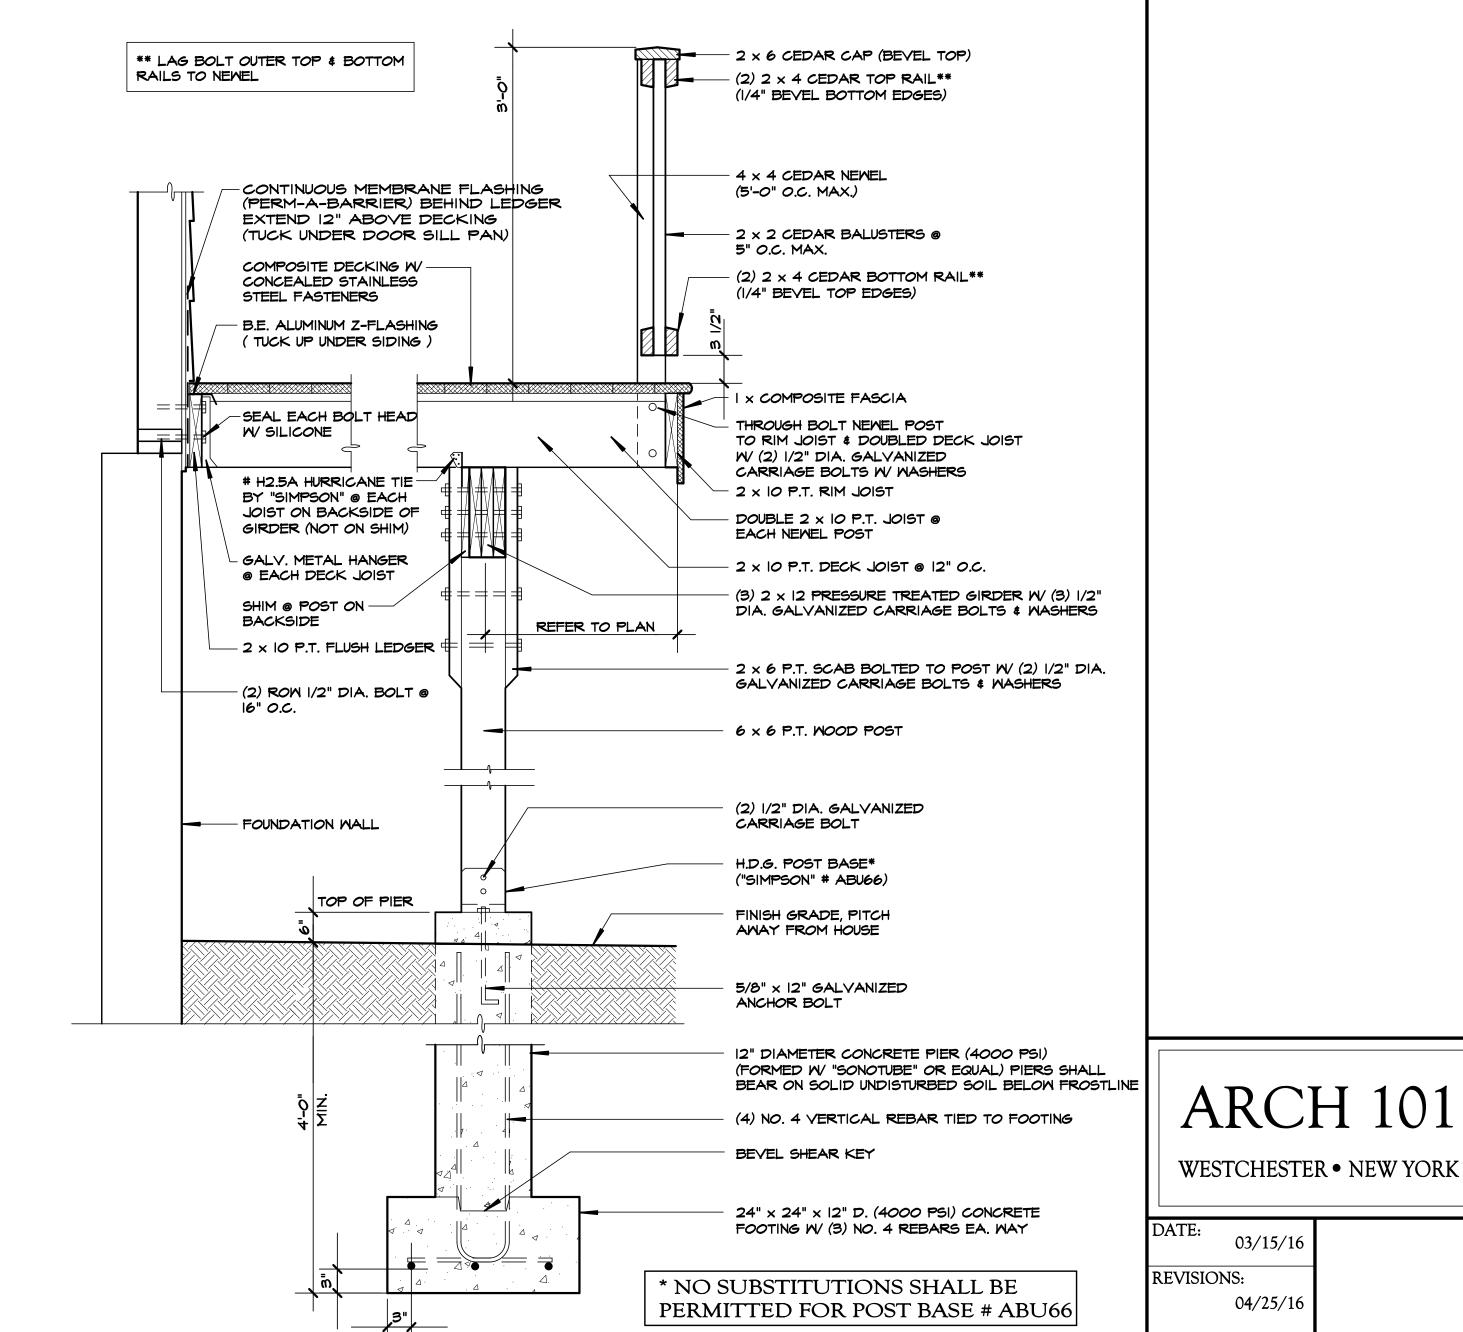

A WOOD DECK SECTION

SCALE: 1" = 1'-0"

DO NOT NOTCH NEWEL POSTS

NOTE: • ALL NAILS (RING SHANK) AND SCREWS SHALL BE STAINLESS STEEL.

DATE: 03/15/16

REVISIONS: 04/25/16

ARCHITECTS SEAL DWG No. A20
DETAILS

23 shawnee rd/216002

23 Shawnee Road, LLC

Proposed Residence

23 Shawnee Road Scarsdale N.Y.